Type Design

Ramechhap / Dhading














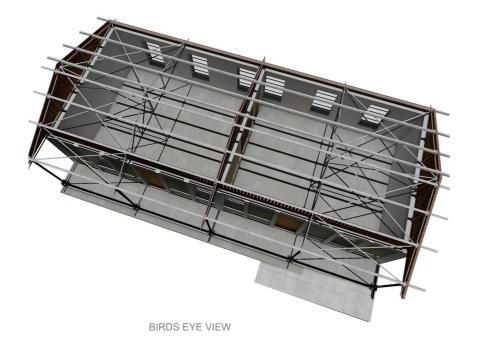



Summary



| Architectural Drawings | 04-09 |
|------------------------|-------|
| Architectural Details | 11-14 |
| Structural Details | 16-30 |
| Master Plans | 32-41 |

Architectural Drawings

Ramechhap / Dhading















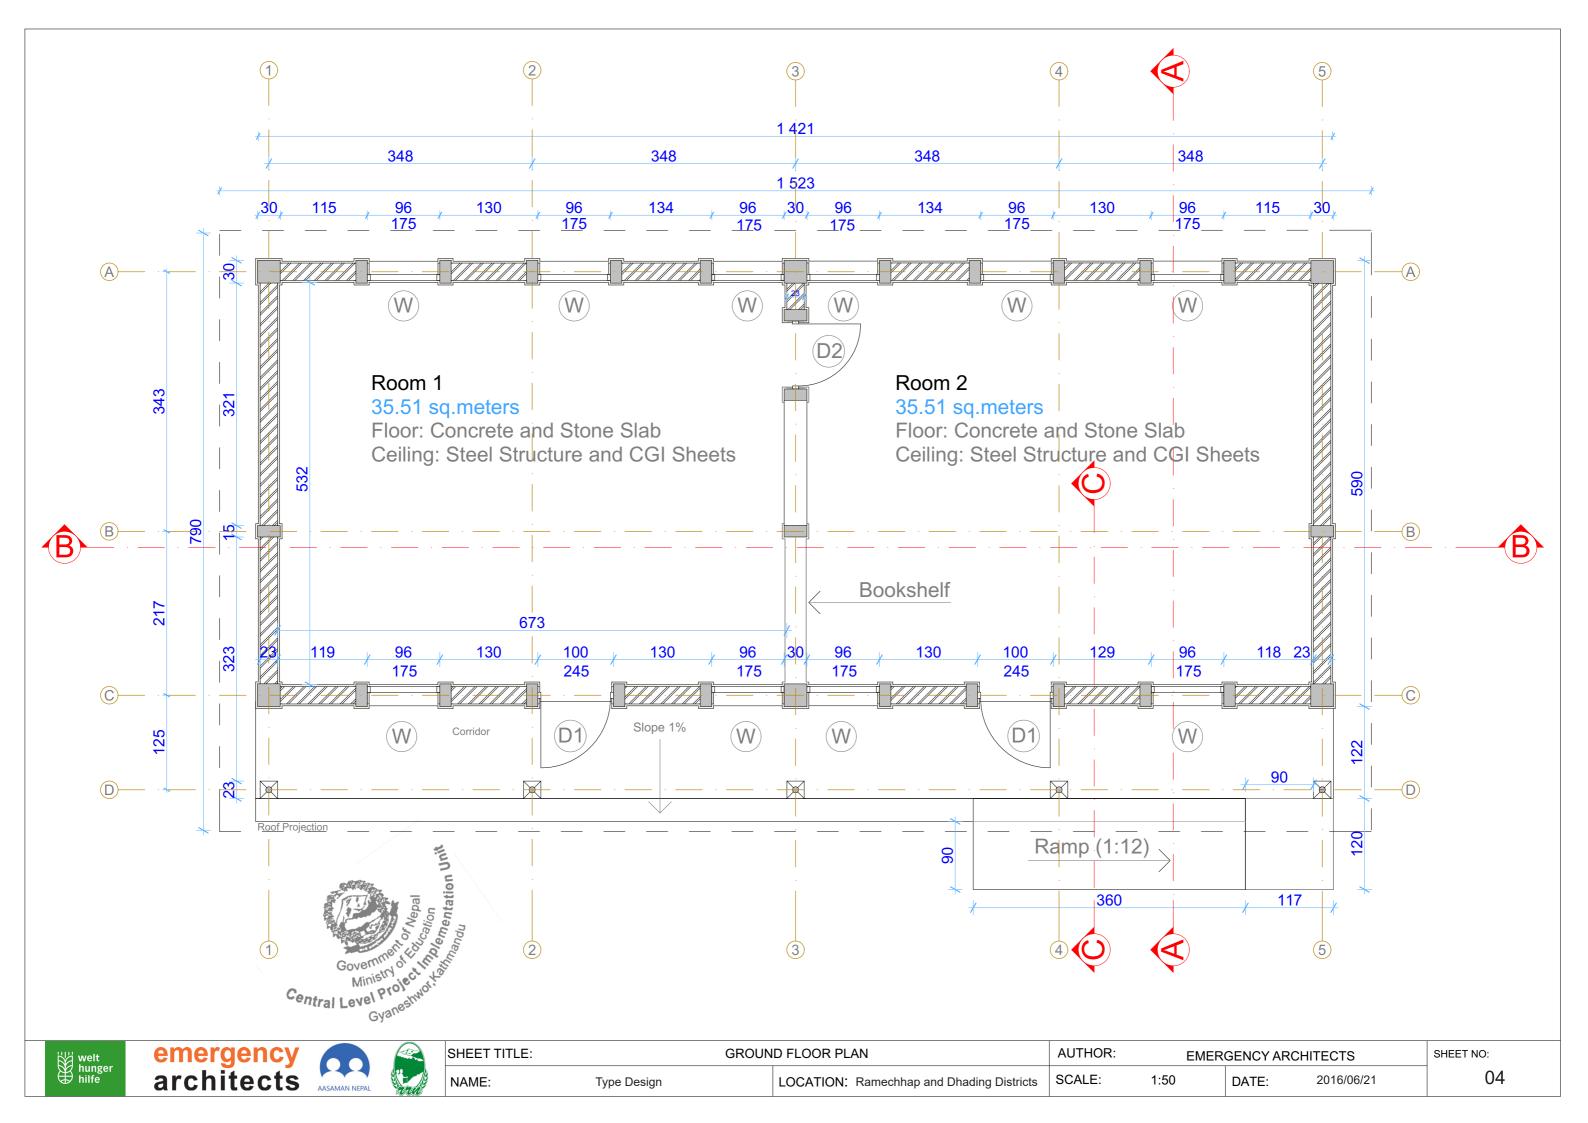

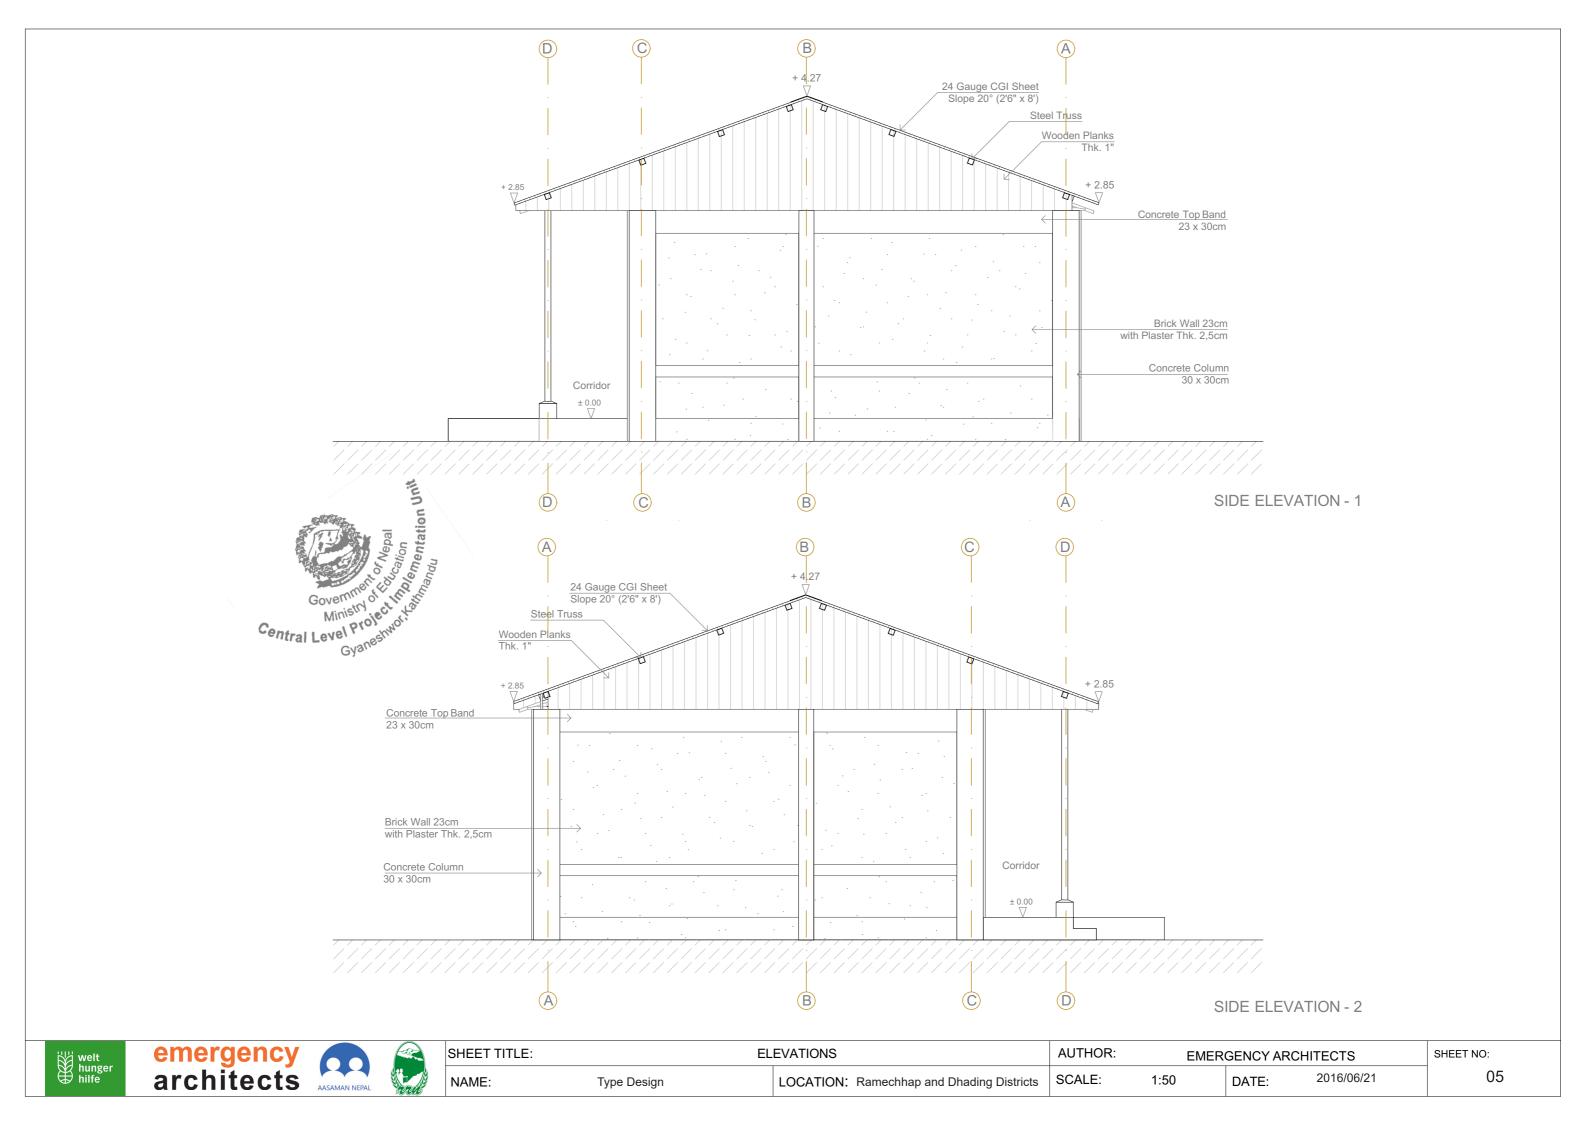

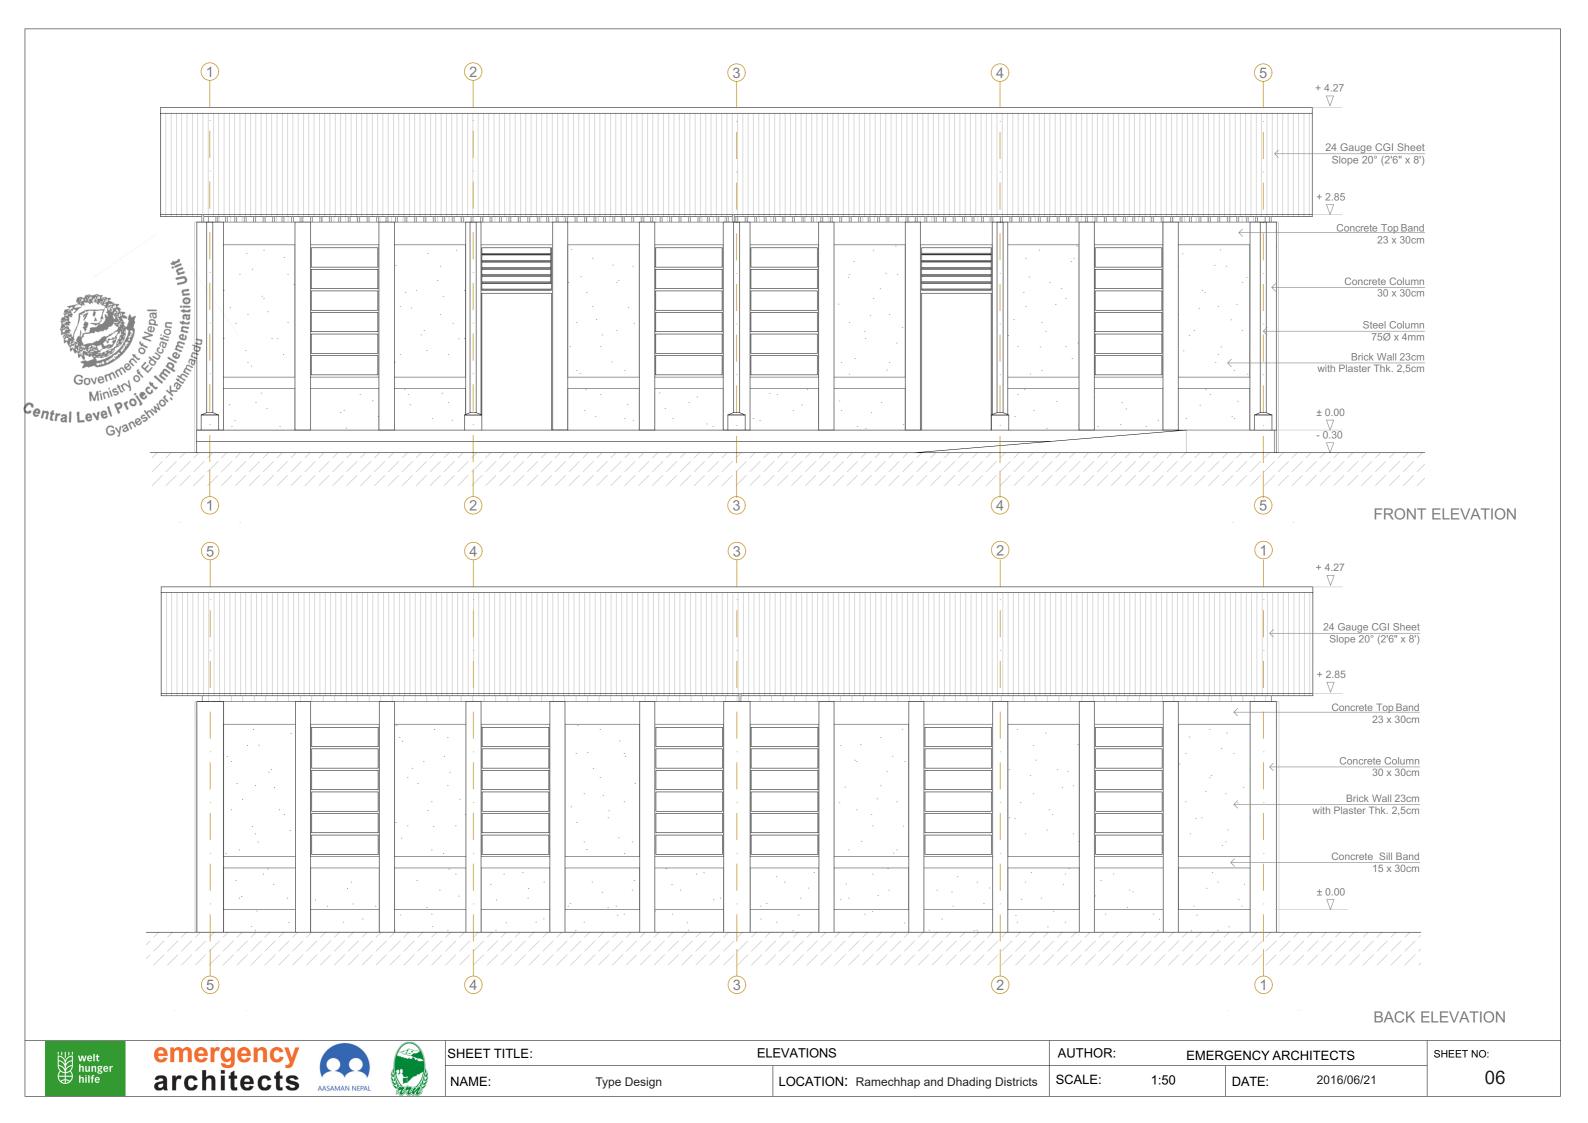

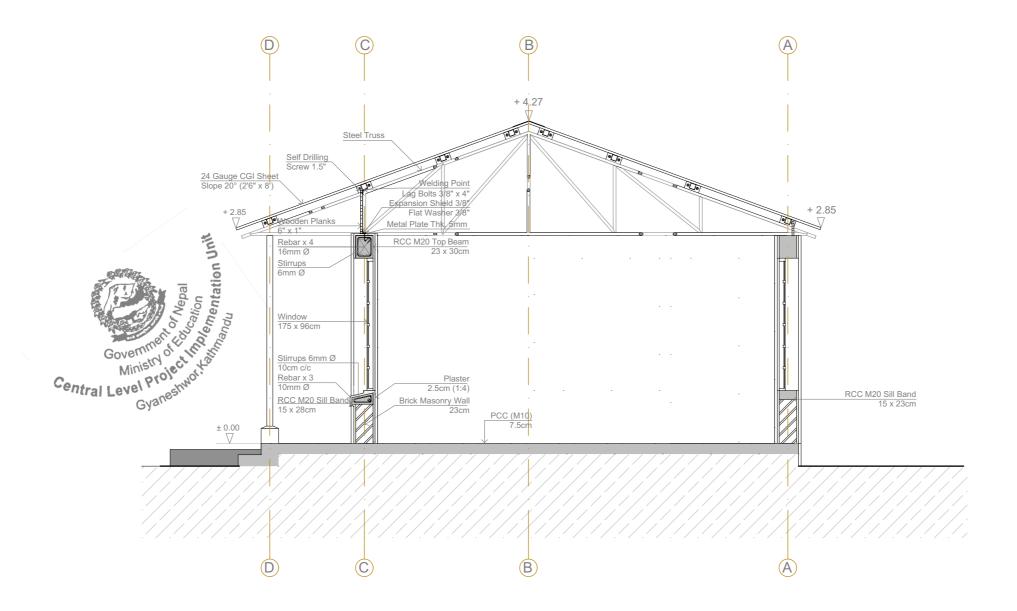

SECTION A - A










| SHE |
|-----|
| NAN |

| SHEET TITLE: | |
|--------------|-------------|
| NAME: | Type Design |

LOCATION: Ramechhap and Dhading Districts

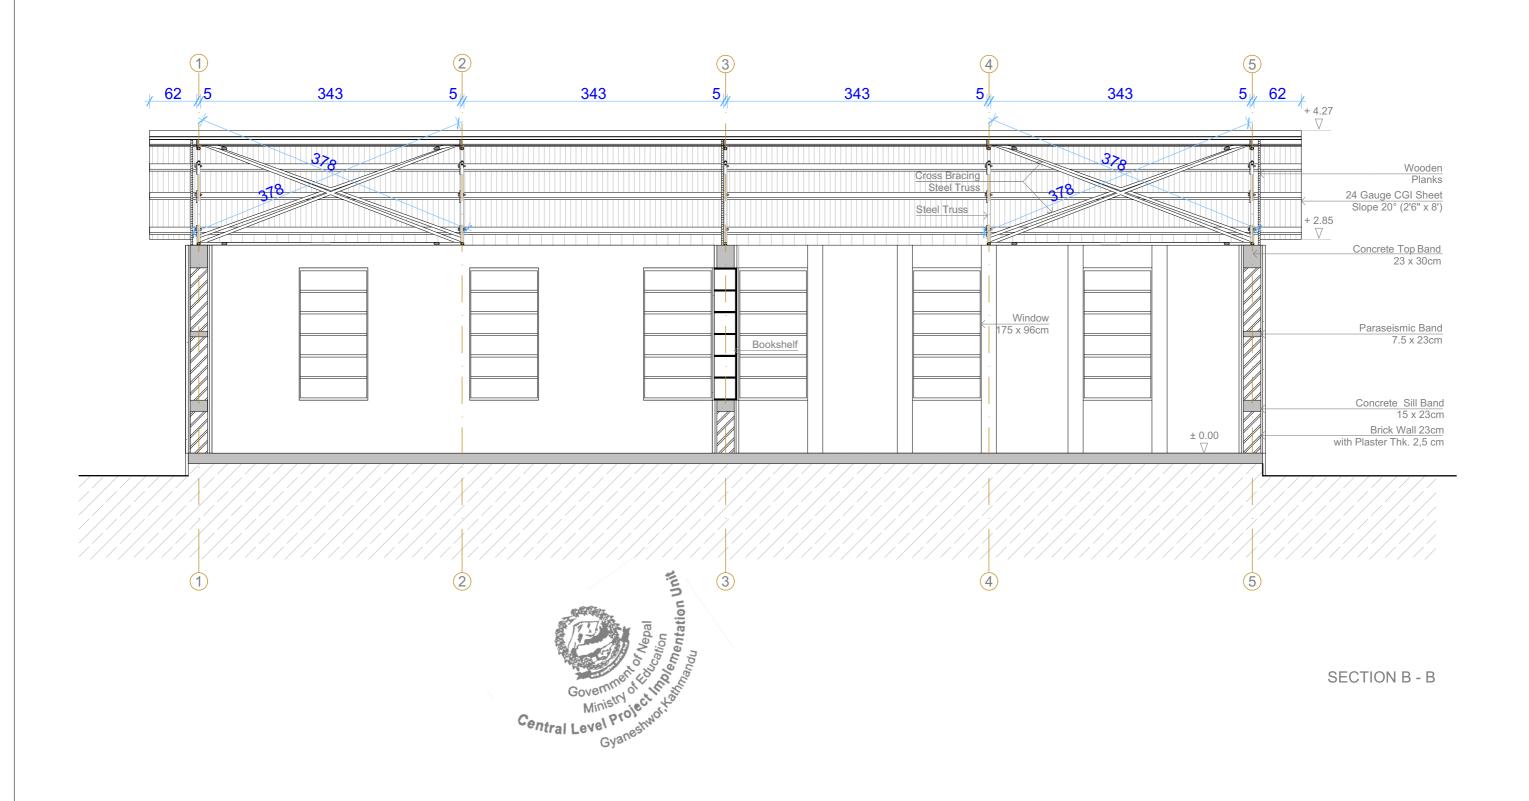









| XI- |
|-----|
| rra |









BACK VIEW



emergency architects ASAMAN NEPAL





| ALC. | |
|-------|--|
| waren | |

| SHEET TITL |
|------------|
| NAME: |

| EET TITLE: | |
|------------|--|
| | |

Type Design

PERSPECTIVE VIEW

AUTHOR:

EMERGENCY ARCHITECTS

SHEET NO: 09

2016/06/21 SCALE: 1:50 LOCATION: Ramechhap and Dhading Districts DATE:

Architectural Details

Ramechhap / Dhading












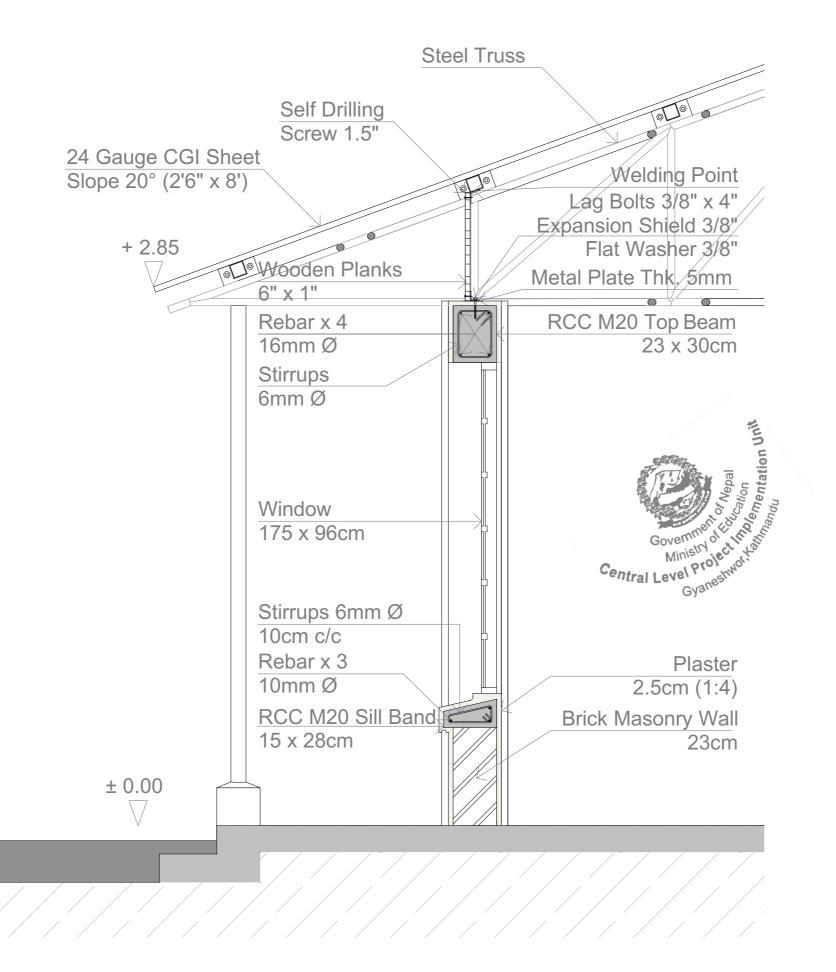












| SHEET TITLE: | DETAIL SECTION | | |
|--------------|----------------|--|---|
| NAME: | Type Design | | LOCATION: Ramechhap and Dhading Districts |

AUTHOR:

EMERGENCY ARCHITECTS

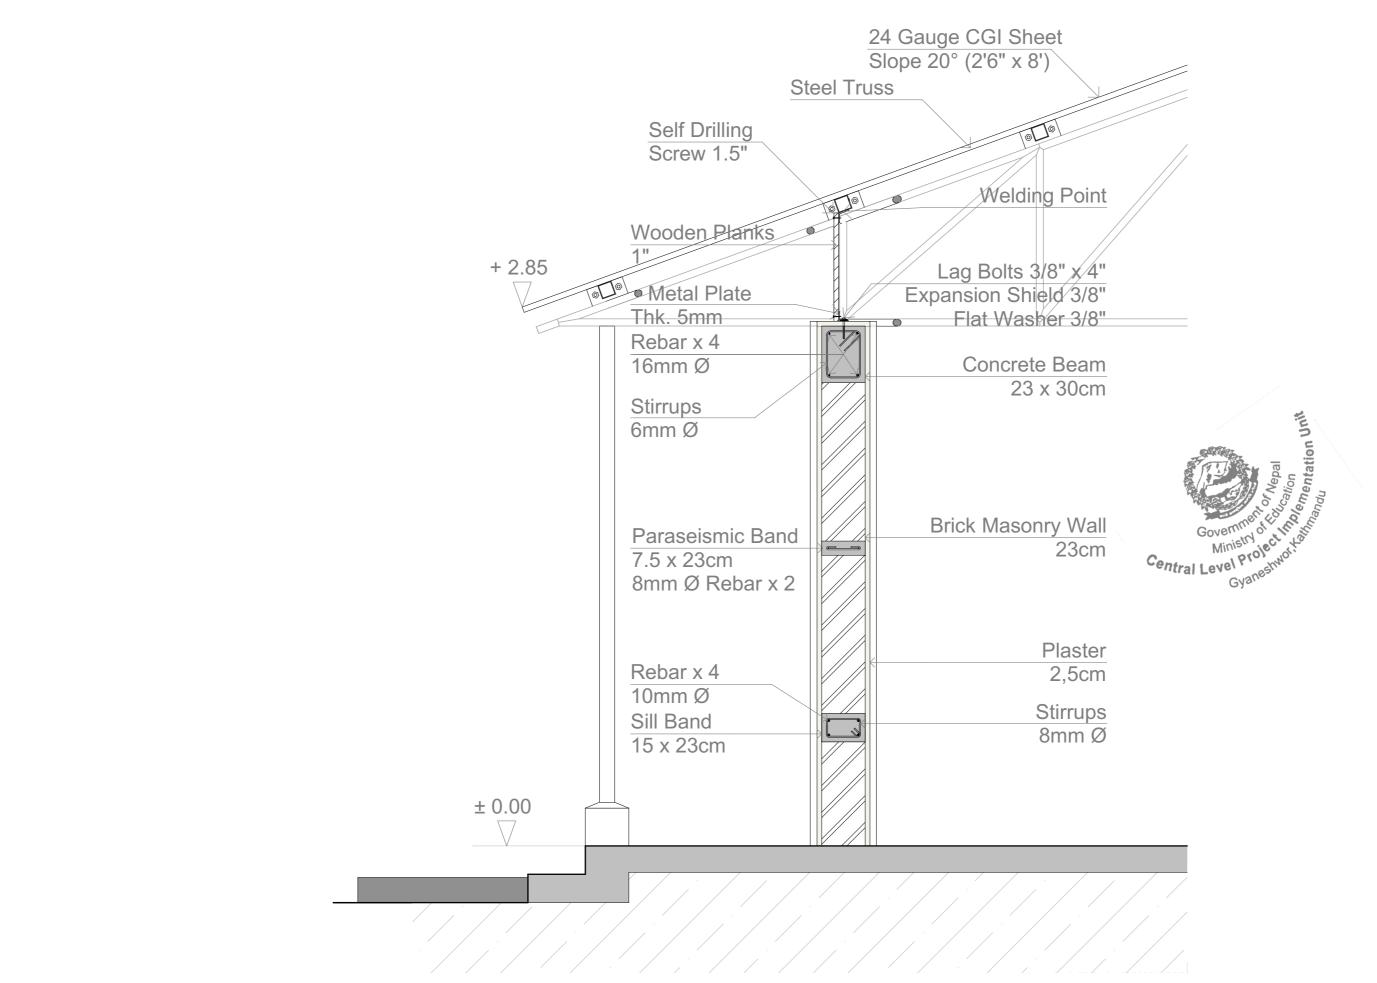












Type Design

LOCATION: Ramechhap and Dhading Districts

1:20

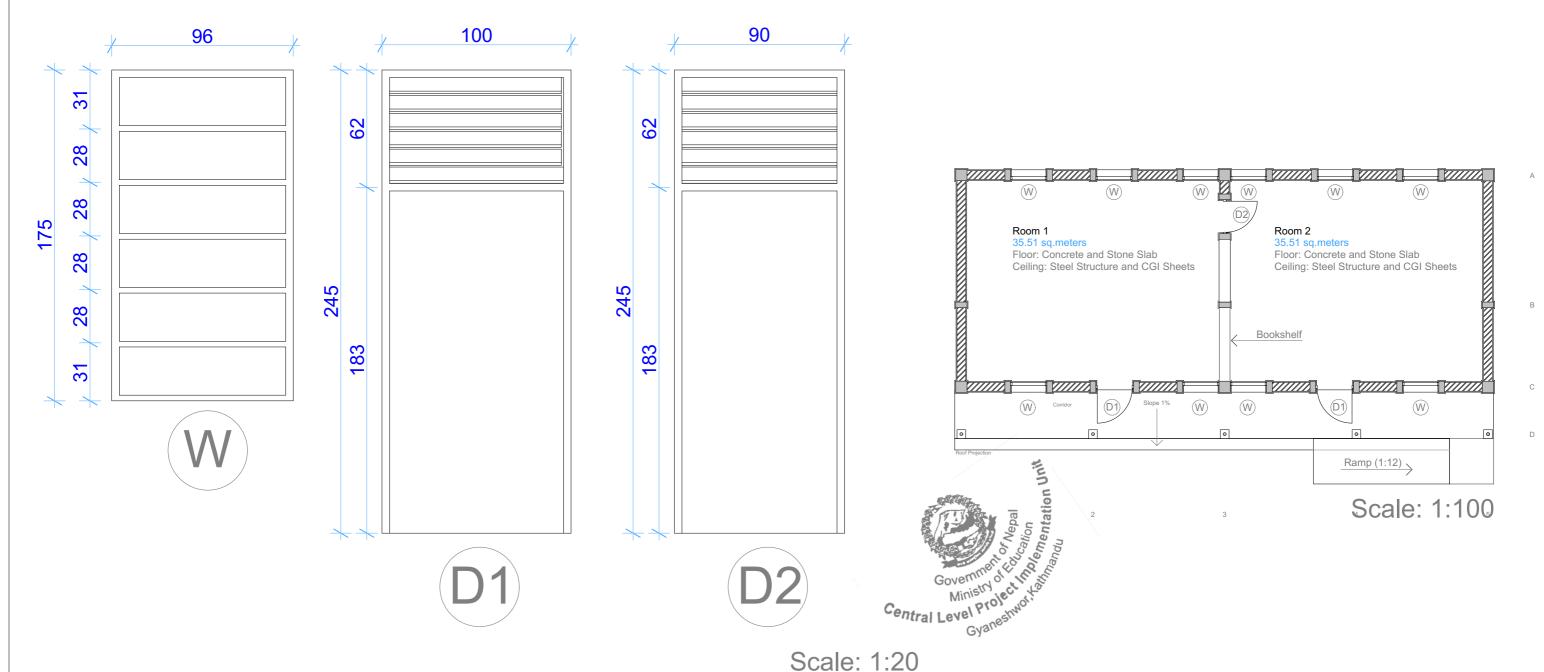

Scale: 1:20

OPENING SCHEDULE

| SNo. | DESCRIPTION | SYMBOL | NOs. | SIZE | REMARKS |
|------|-------------|--------|------|--------------|---------|
| 1 | DOOR | D1 | 2 | 100 X 245 cm | |
| 2 | DOOR | D2 | 1 | 90 X 245 cm | |
| 3 | WINDOW | W | 10 | 96 X 176 cm | |










| A. | SHE |
|----------------|-----|
| and the second | NAN |

| SHEET TITLE: | | OPENING SCHEDULE | |
|--------------|-------|------------------|---------------------------------|
| | NAME: | Type Design | LOCATION: Ramechhap and Dhading |

SHEET NO:

13

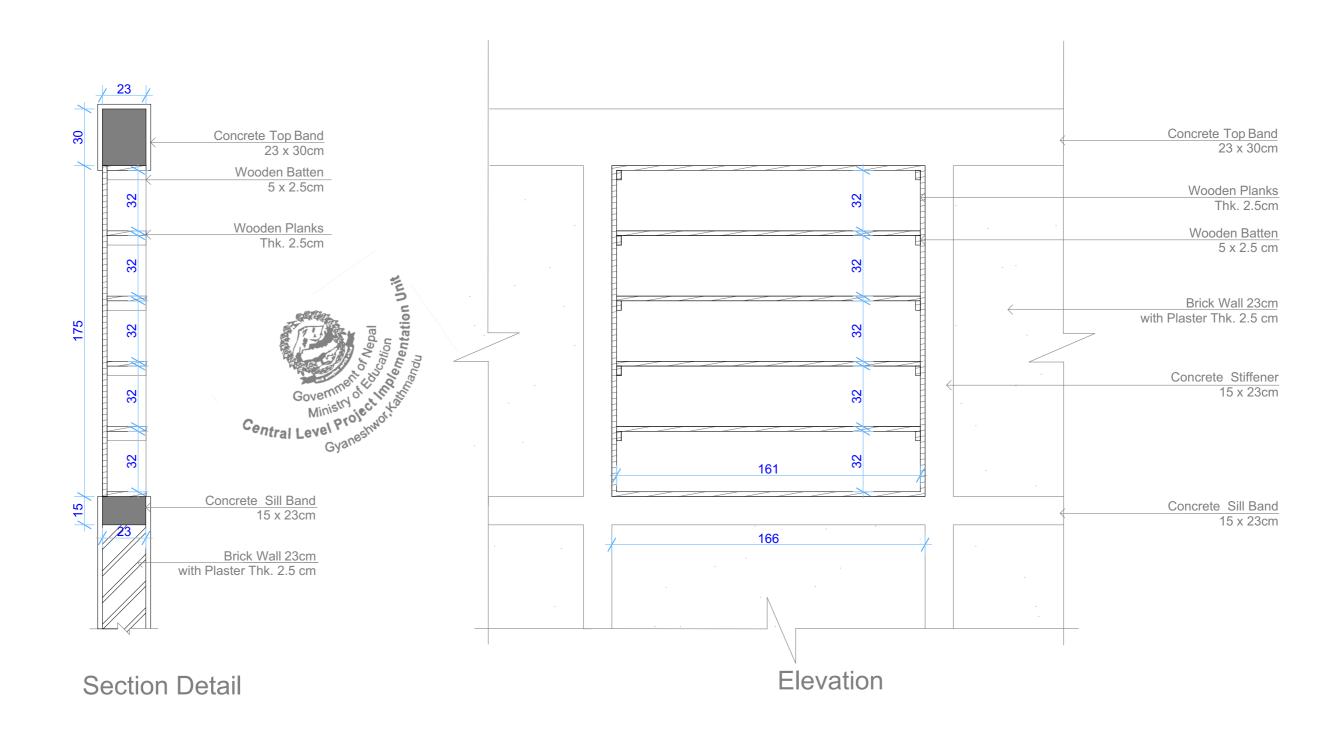











| SHEET TI |
|----------|
| NAME: |

AUTHOR:

Structural Details

Ramechhap / Dhading












GENERAL NOTE:-


- I. ONLY WRITTEN DIMENSIONS SHALL BE FOLLOWED, DRAWINGS SHALL NOT BE MEASURED
- 2. ANY DISCREPANCY IF FOUND SHALL BE REPORTED TO THE SITE ENGINEER
- 3. USE M20 (I:1.5:3) GRADE CONCRETE FOR COLUMN, FOUNDATION & SILL BANDS (ALL RCC WORKS)
- 4.FE4I5 GRADE STEEL (FY=4I5N/MM²)
- 5. CLEAR COVER TO BARS
 - A. FOR CONCRETE MEMBERS IN CONTACT WITH SOIL = MIN 50MM
 - B. FOR LONGITUDINAL (VERTICAL) BARS IN COLUMN = 40MM
 - C. FOR SILL BANDS = 25MM
- 6. BARS IN COLUMNS SHALL BE SPLICED ONLY AT MID HEIGHT OF COLUMN
- 7. DEVELOPMENT / LAP LENGTH (LD.) FOR BARS

8 10 12 16 25 BAR DIA-(MM) 20 FOR M20 LD 912 1140 1425 456 570 684


- 8. PROVIDE SHEAR REINFORCEMENT AT 100 C/C AT LAP LOCATIONS
- 9. H = CLEAR SPAN OF FLOOR


10. H = H/6, OR 450MM WHICHEVER IS GREATER

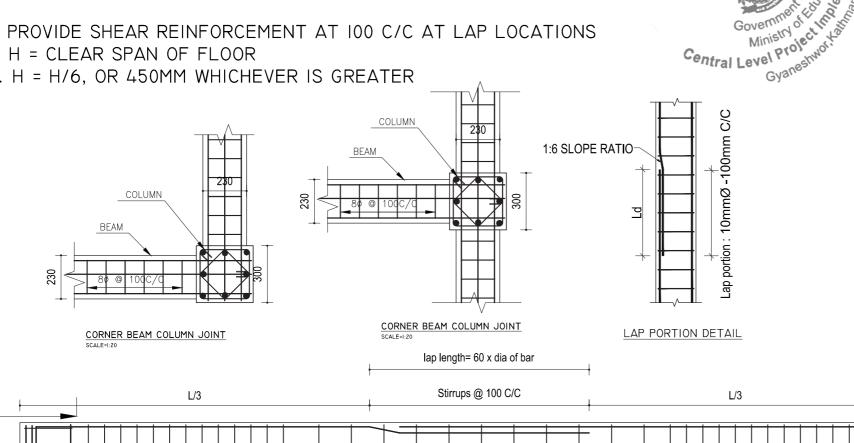

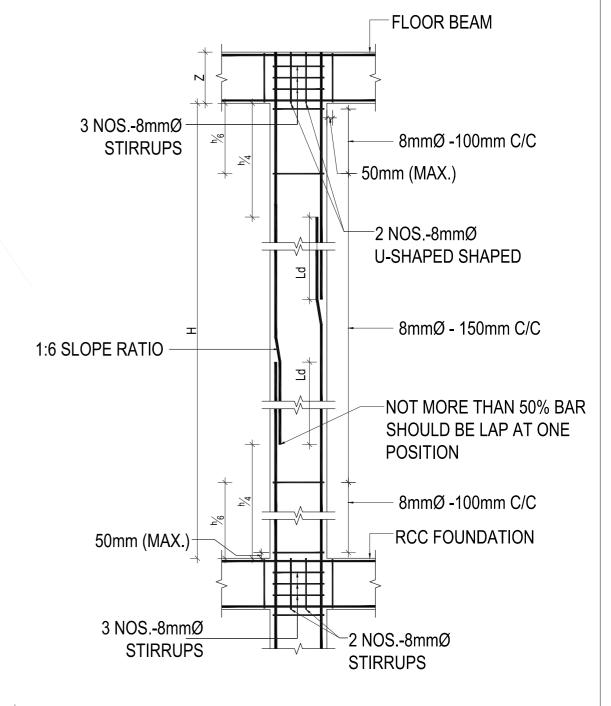

TYP. COLUMN SHEAR REINFORCEMENT DETAIL

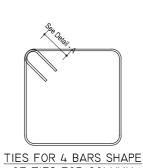

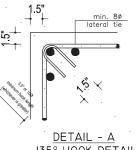

OF TIES FOR COLUMN

-135° HOOK DETAIL



Ь О





3 parts out of 8 parts of length

Bottom bar lap place(60Ø)



| SI |
|----|
| N |

| | SHEET TITLI |
|----------|-------------|
| <u> </u> | NAME: |

L/4

LAP DETAIL IN BEAM

General notes and typical details

Type Design

Bottom bar lap place(60Ø)


3 parts out of 8 parts of length


LOCATION: Ramechhap and Dhading Districts

AUTHOR:

SCALE: AS MENTIONED DATE:

EMERGENCY ARCHITECTS 2016/06/21

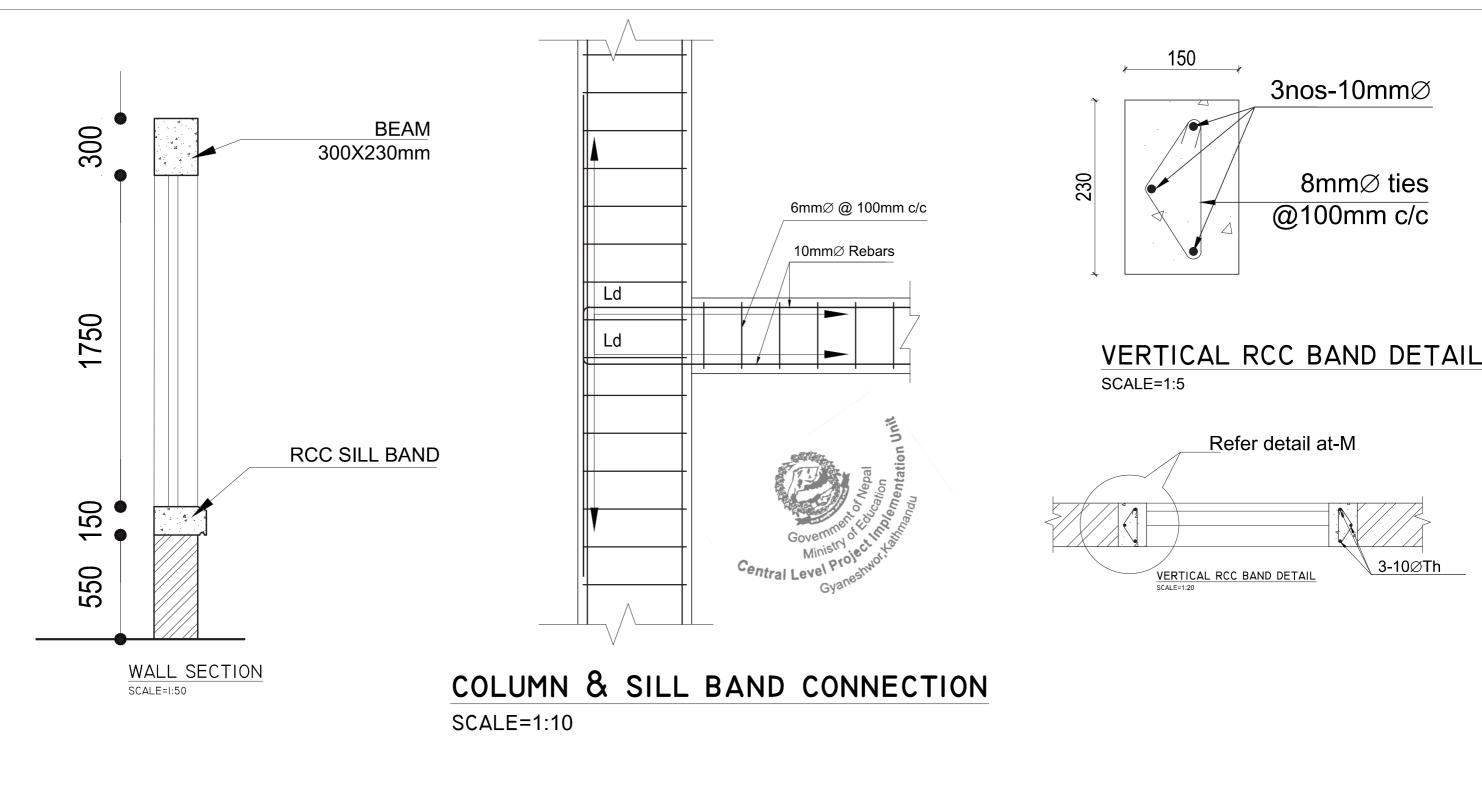

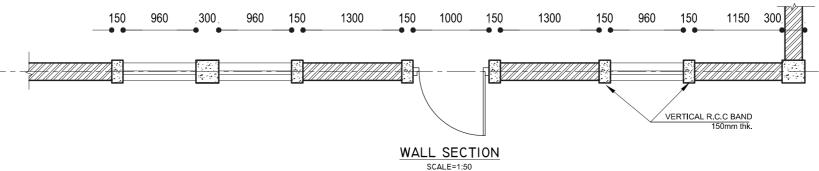











| SHEET TITLE: |
|--------------|
| NAME: |





LOCATION: Ramechhap and Dhading Districts


AUTHOR:


SCALE: AS MENTIONED

EMERGENCY ARCHITECTS 2016/06/21 DATE:

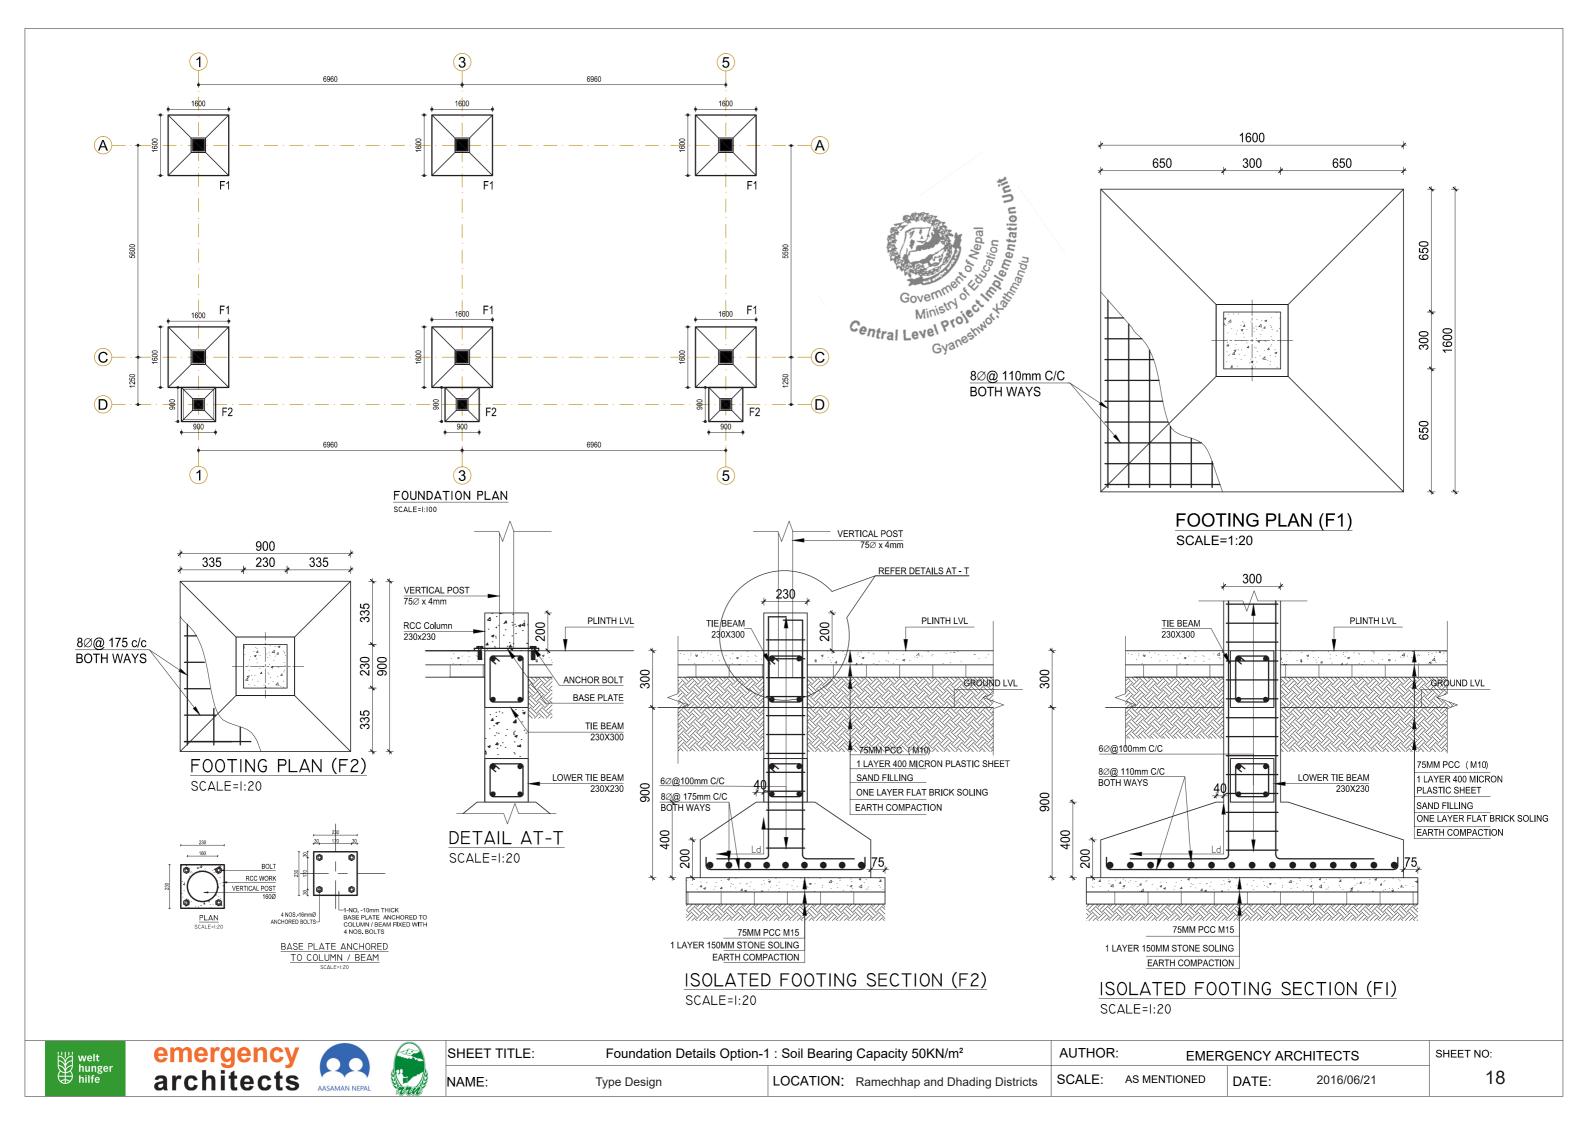

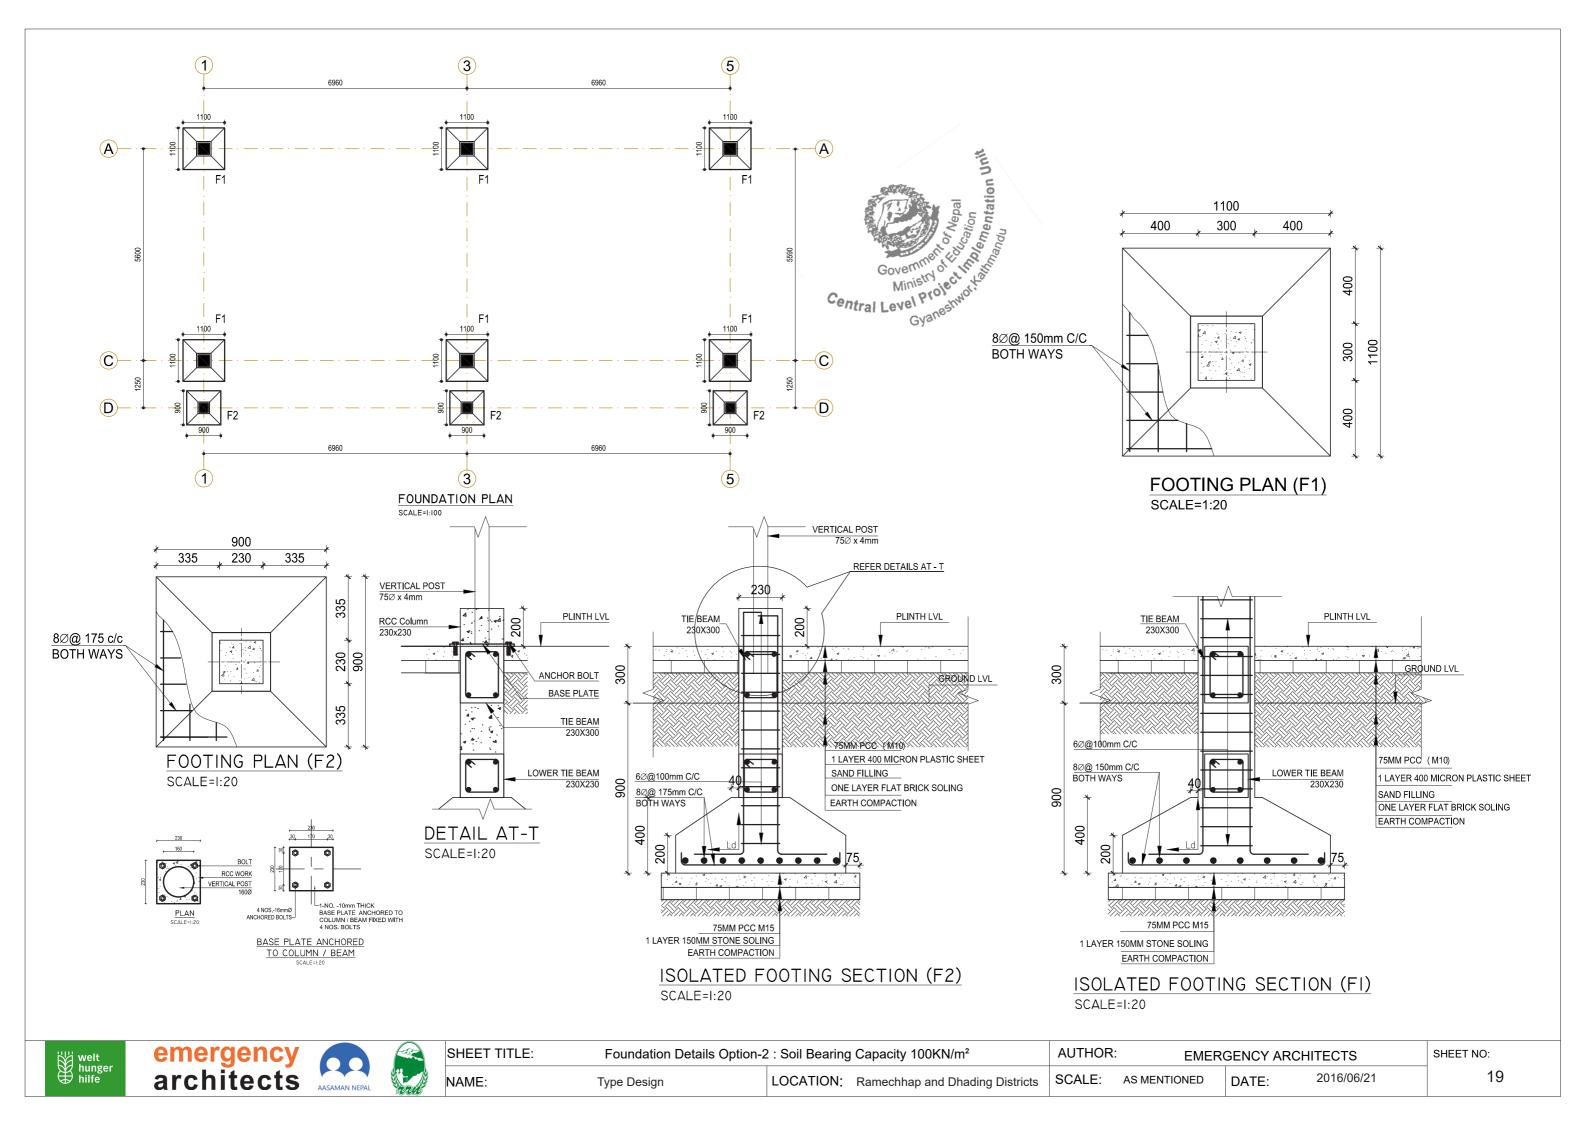

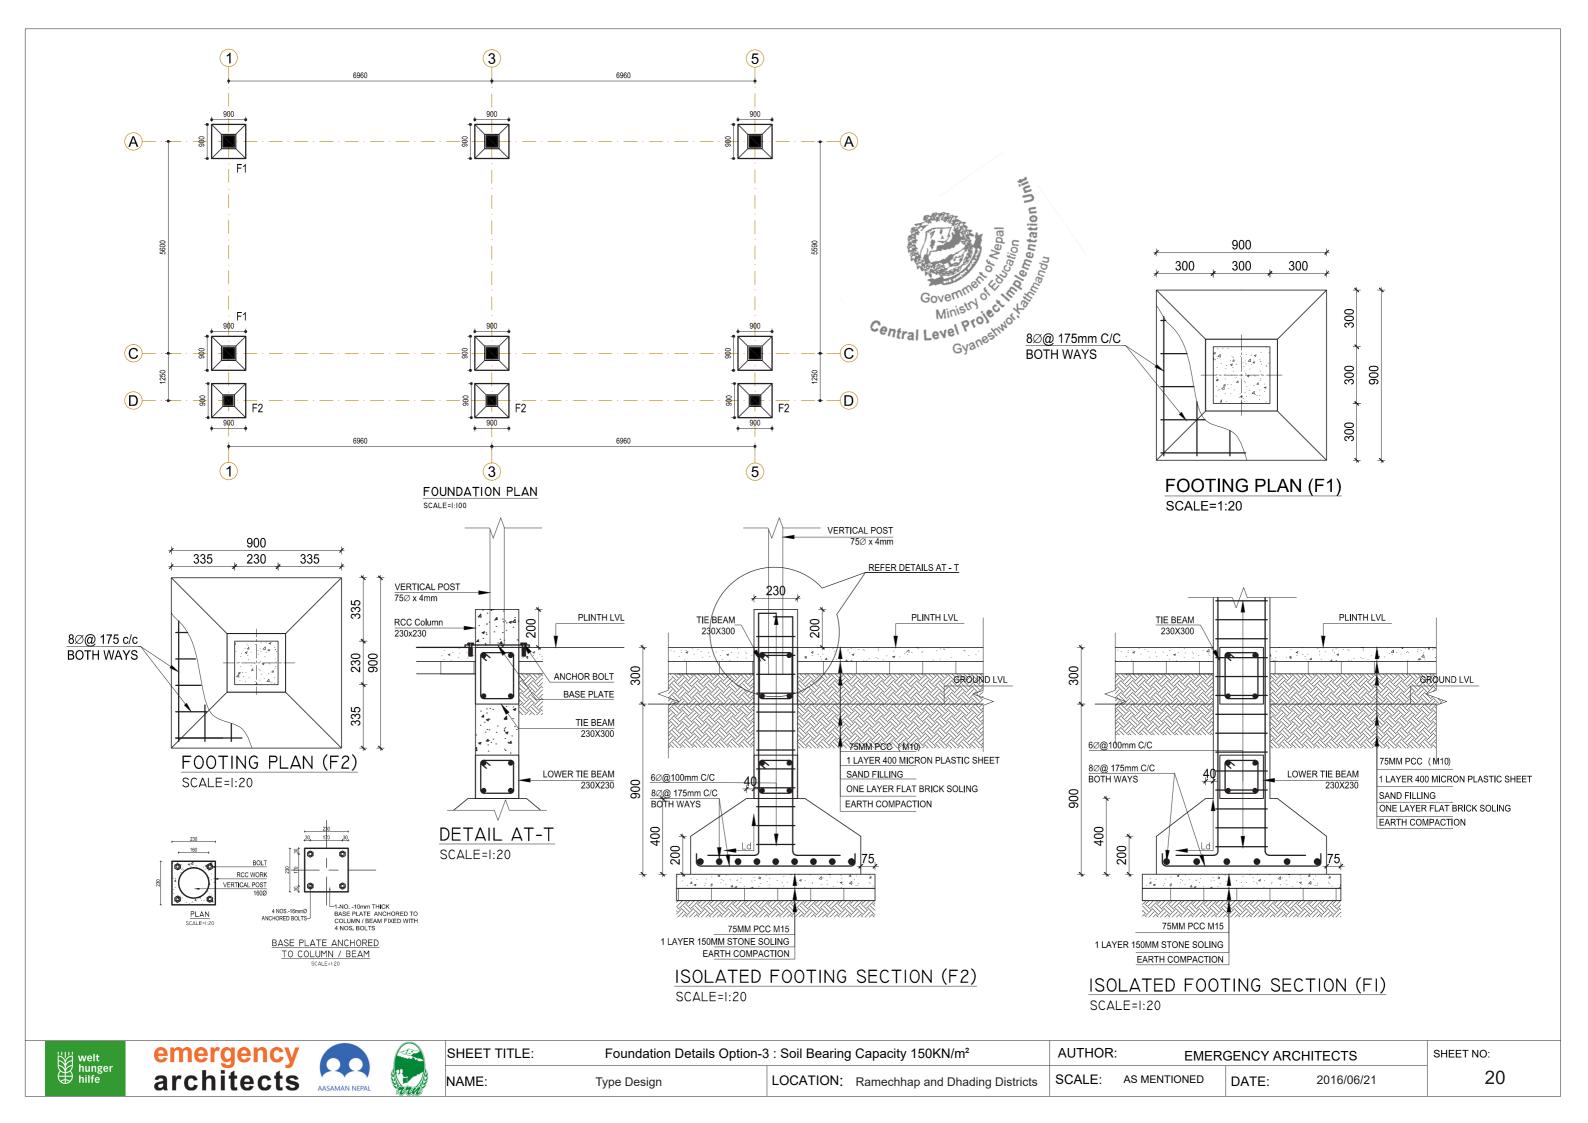

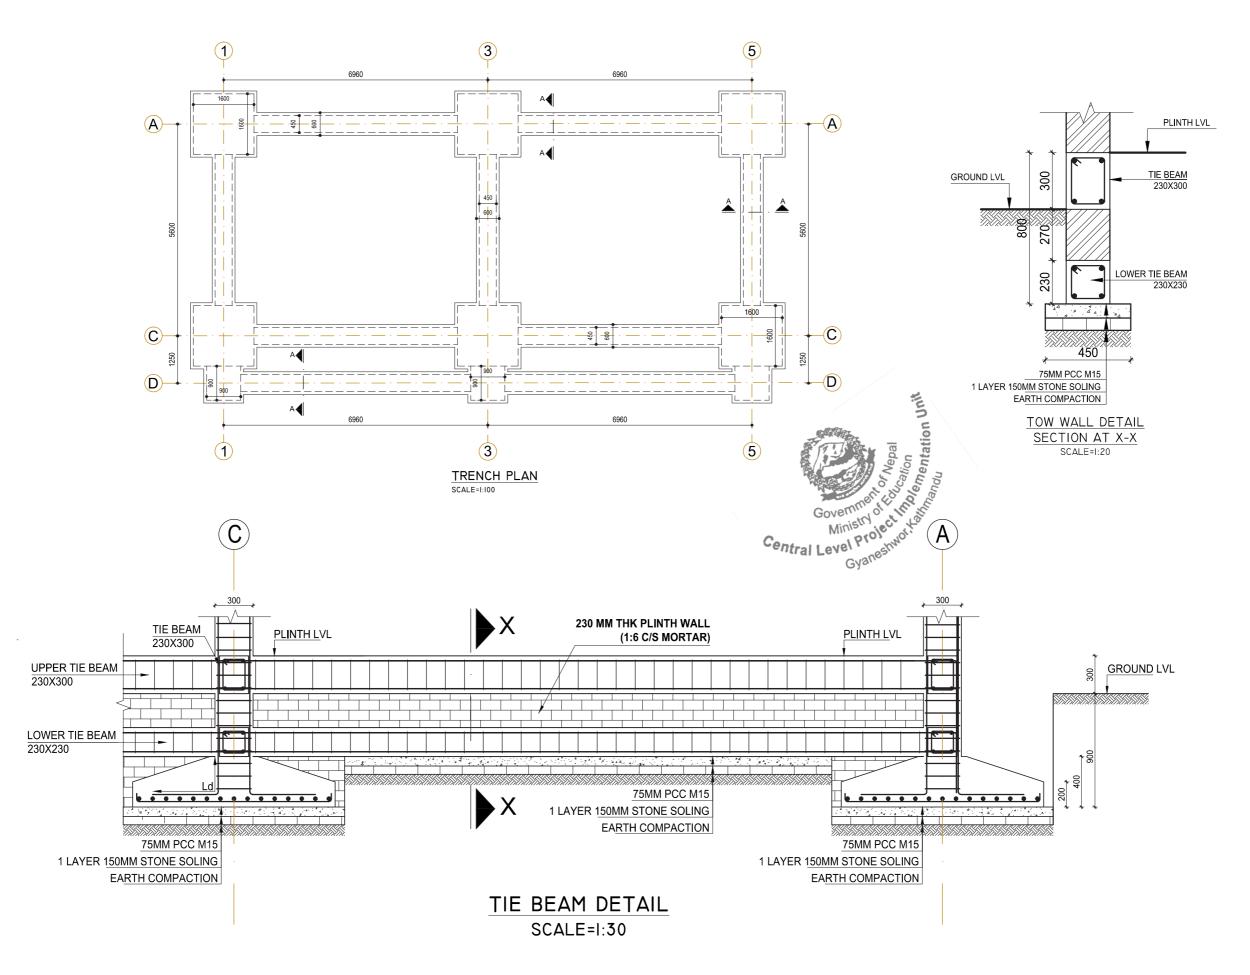











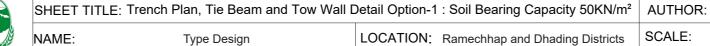

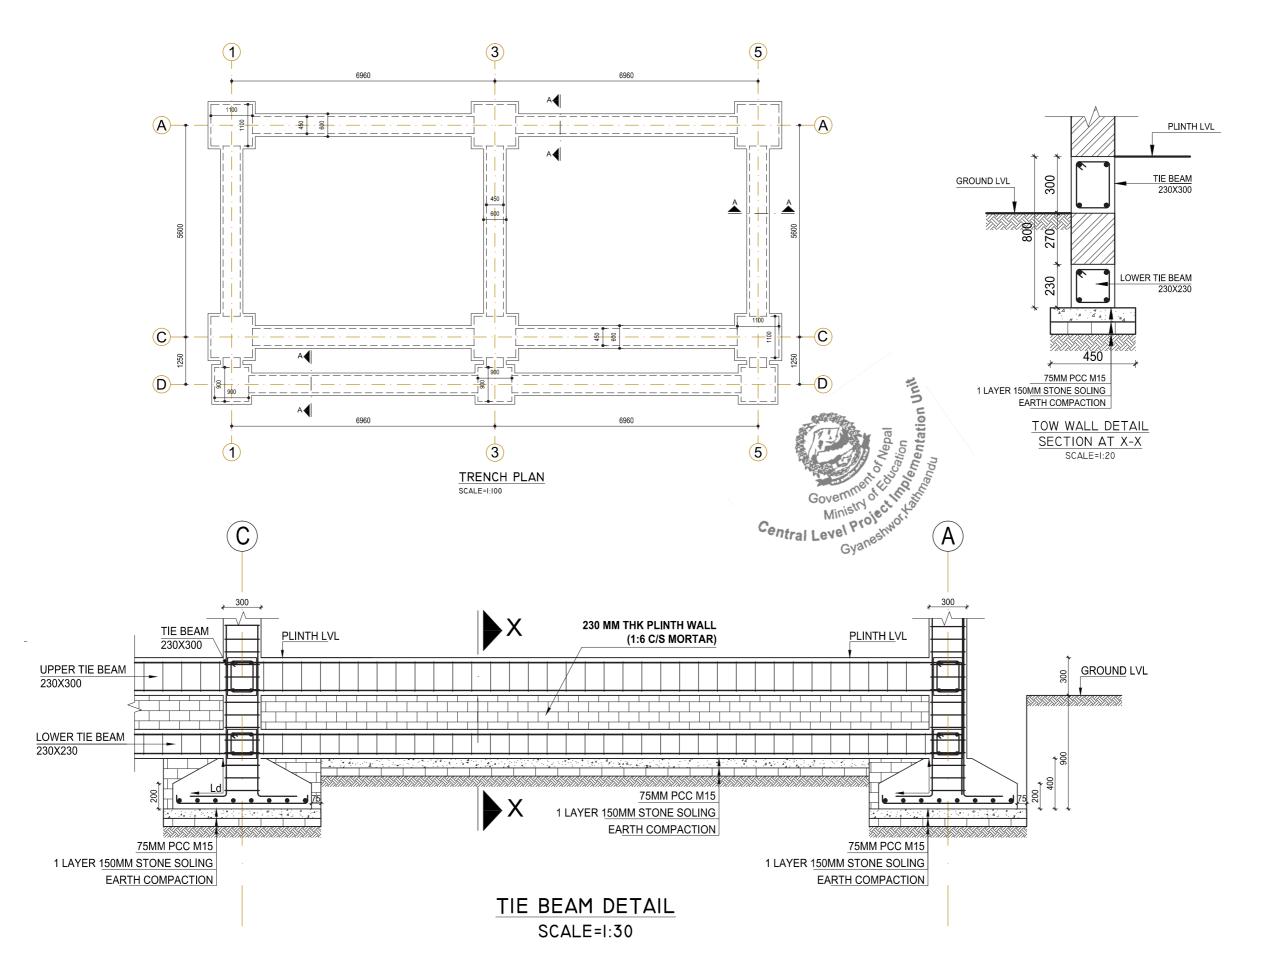










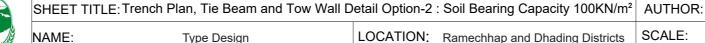


EMERGENCY ARCHITECTS

DATE:

SHEET NO:

Type Design

LOCATION: Ramechhap and Dhading Districts

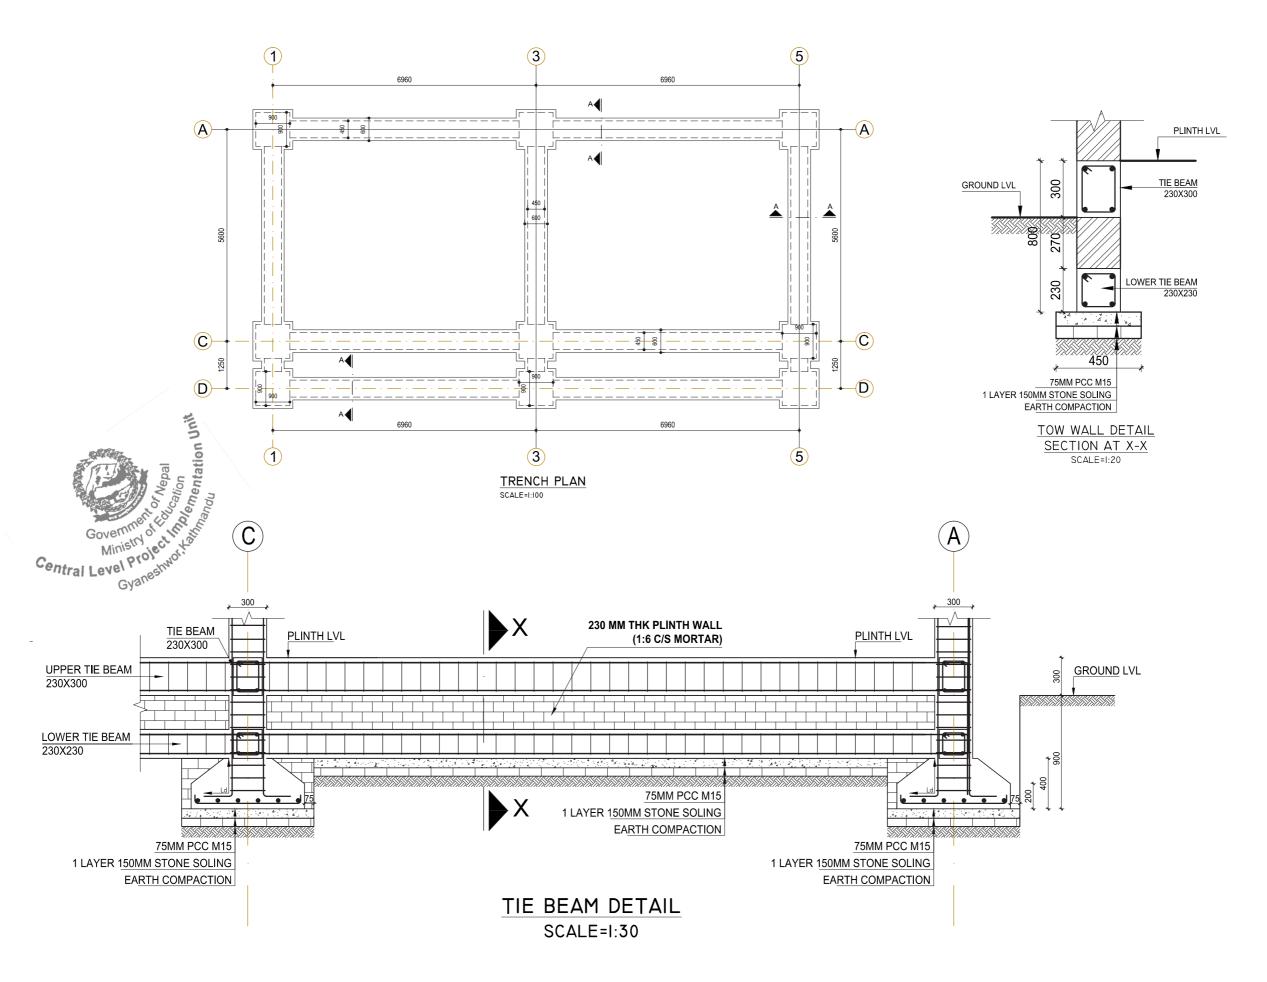












EMERGENCY ARCHITECTS 2016/06/21 SCALE: AS MENTIONED

DATE:

NAME:

LOCATION: Ramechhap and Dhading Districts

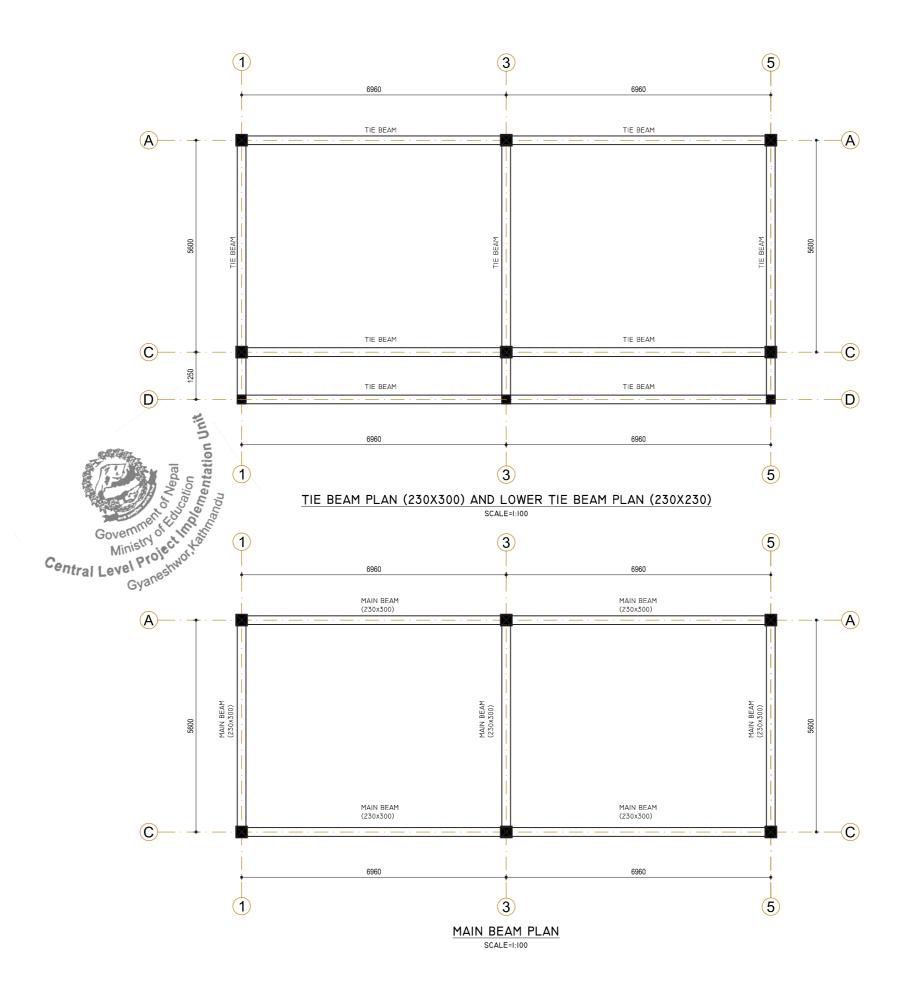












AUTHOR: SCALE: AS MENTIONED

EMERGENCY ARCHITECTS 2016/06/21 DATE:

24

SHEET NO:

NAME: LOCATION: Ramechhap and Dhading Districts Type Design

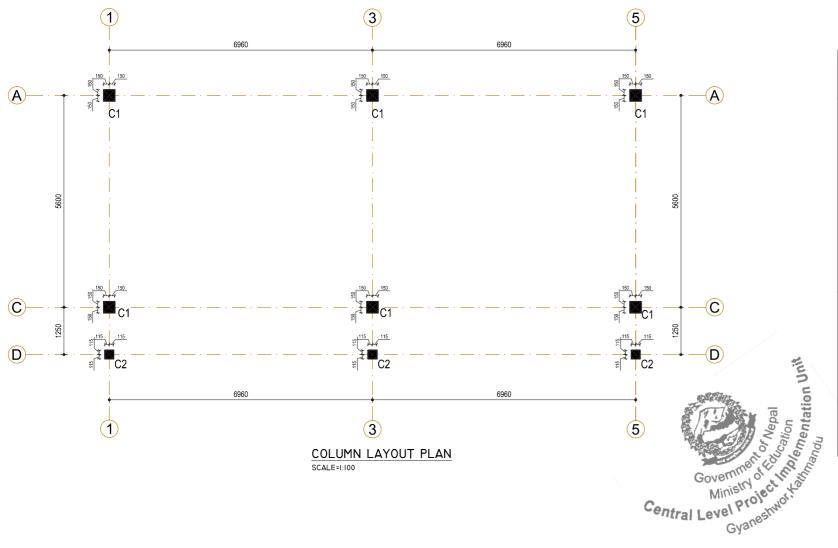

COLUMN REINFORCEMENT DETAIL SCALE= 1:10

| COLUMN NAME | COLUMN SIZE | STIRRUPS | | | |
|-------------|-------------------|----------------------------------|--|--|--|
| C1 | 300 8nos-12mmØ | 6Ø@100c/c end & 150c/c middle | | | |
| C2 | 230 4nos-12mmØ | 6Ø@1OOc/c end & 150c/c middle | | | |












| IEET TITLE: | Column Layout and Column Reinforcement Details | | | | |
|-------------|--|-----------|--|--|--|
| | 5 . | LOCATIONS | | | |

AUTHOR:


EMERGENCY ARCHITECTS 2016/06/21

DATE:

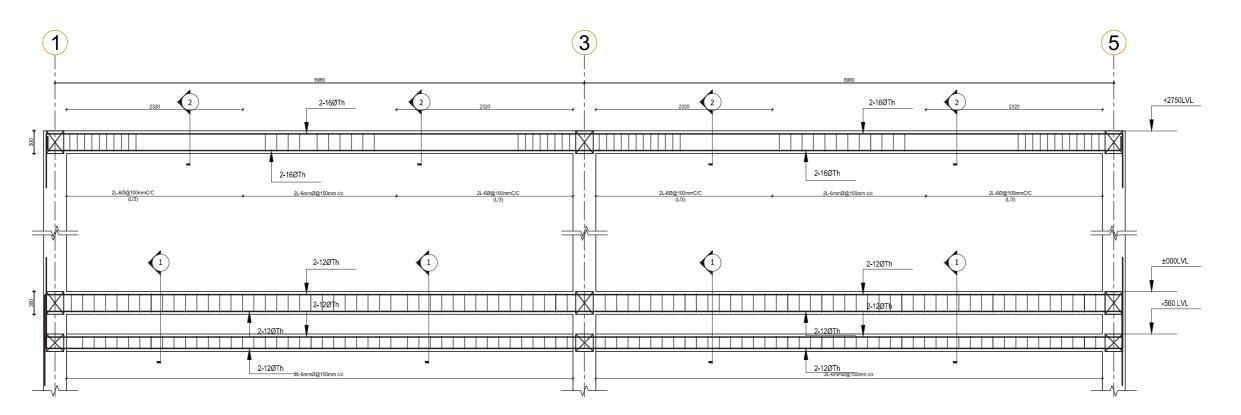

BEAM DETAIL ALONG X-DIRECTION

SCALE=I:50

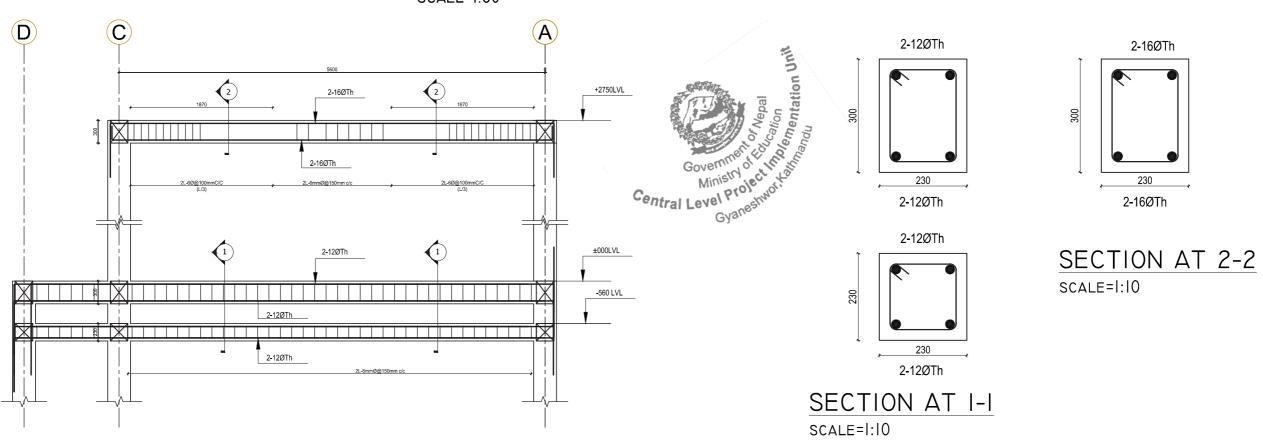

















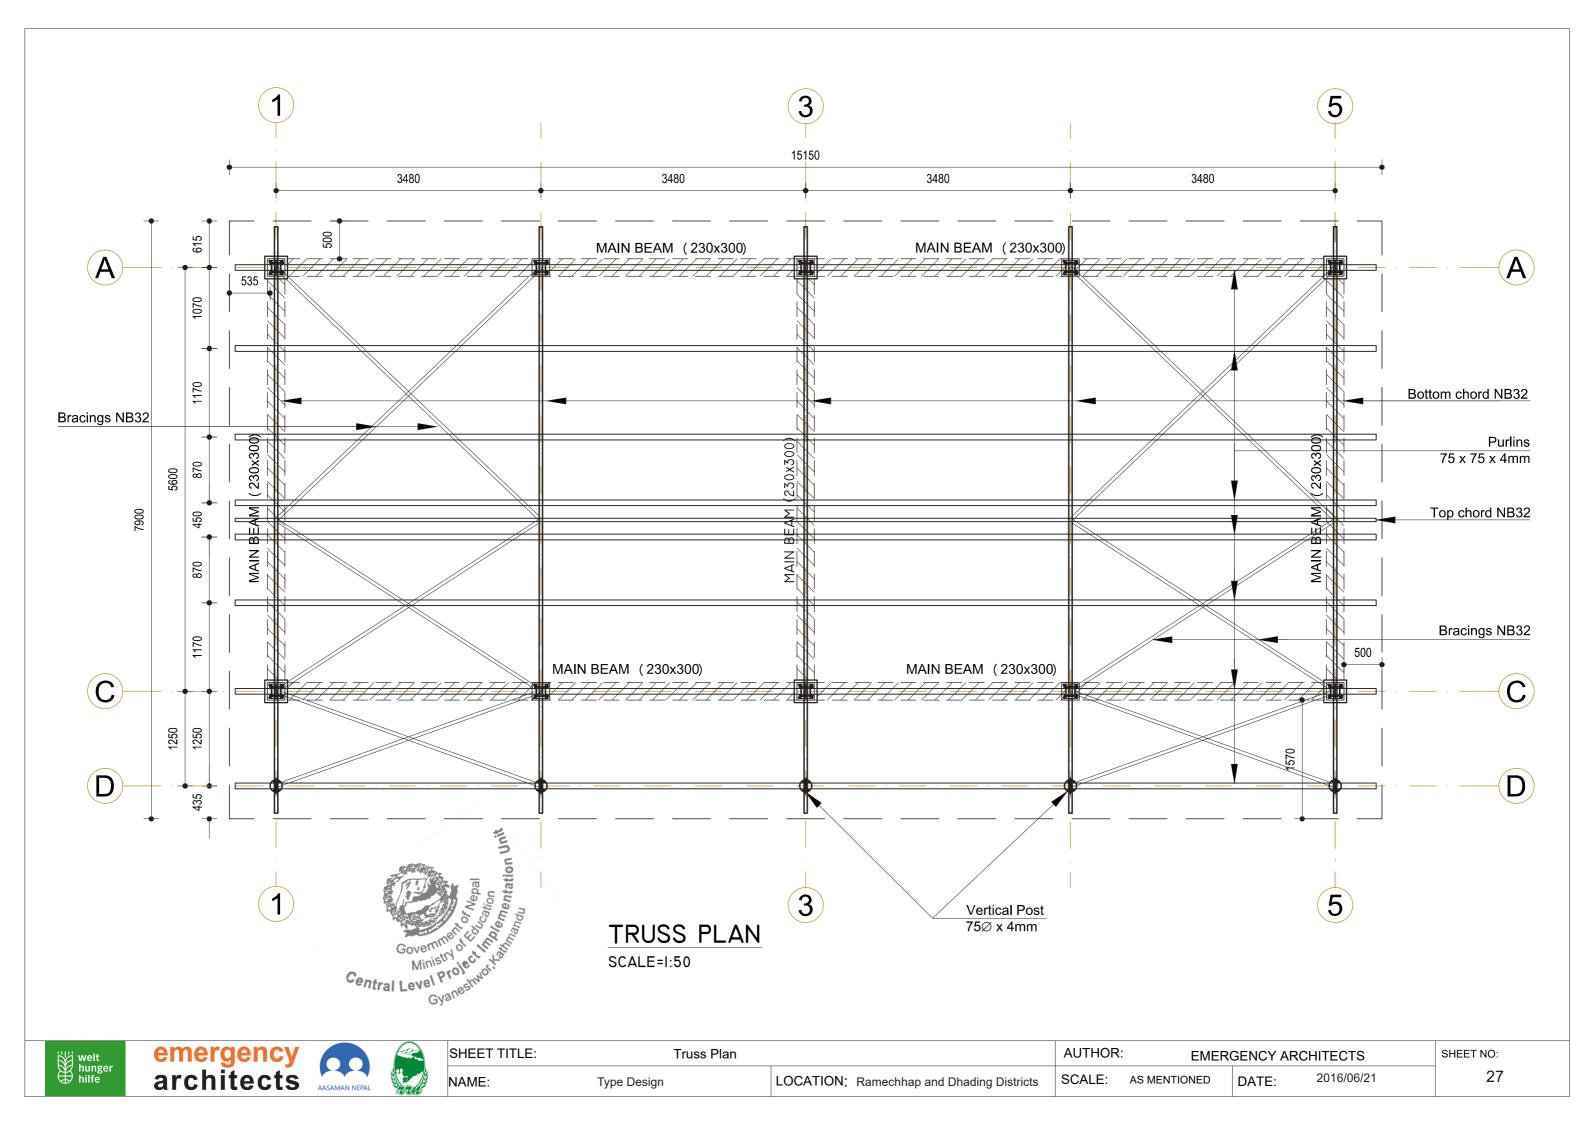

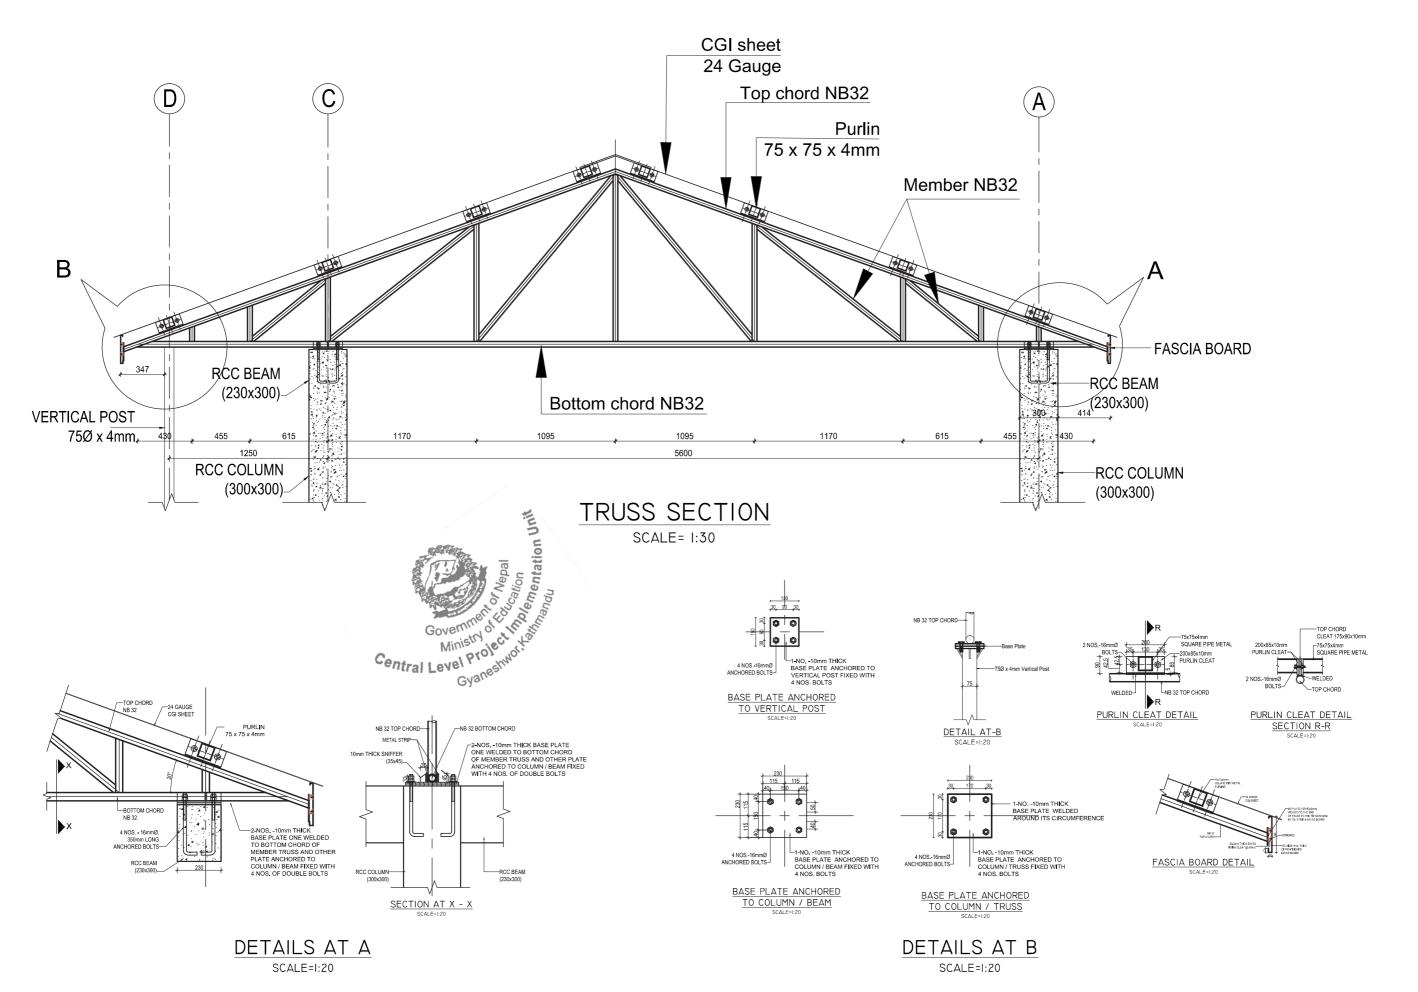












SHEET NO:

2016/06/21

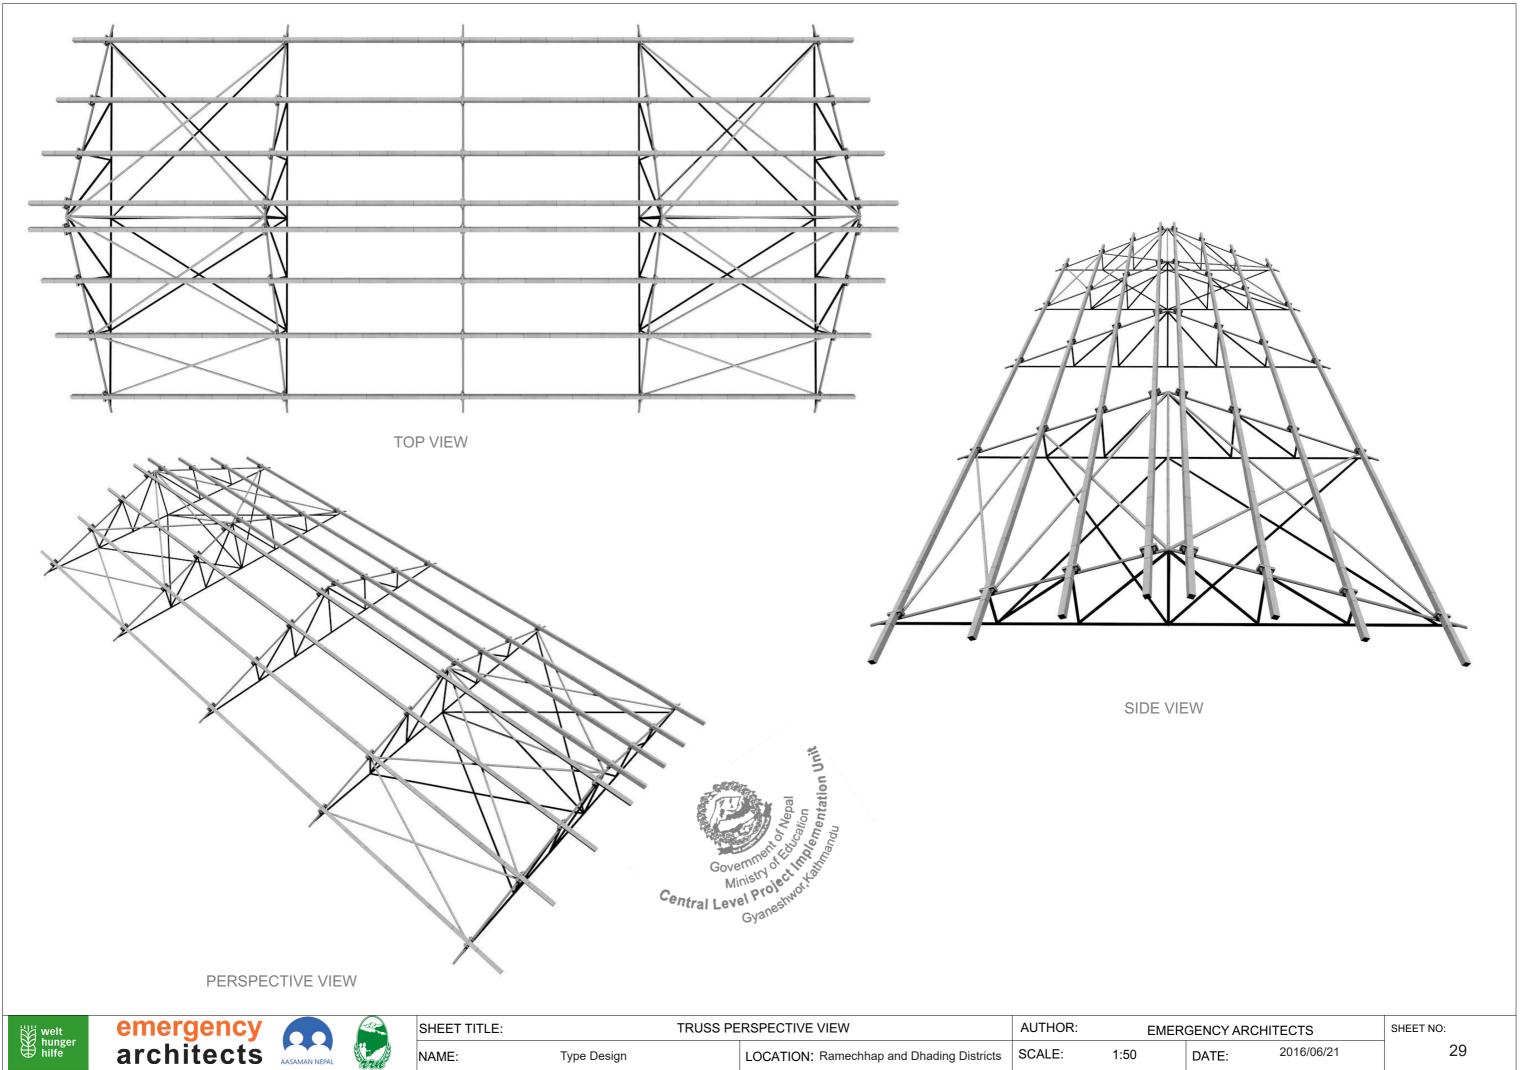












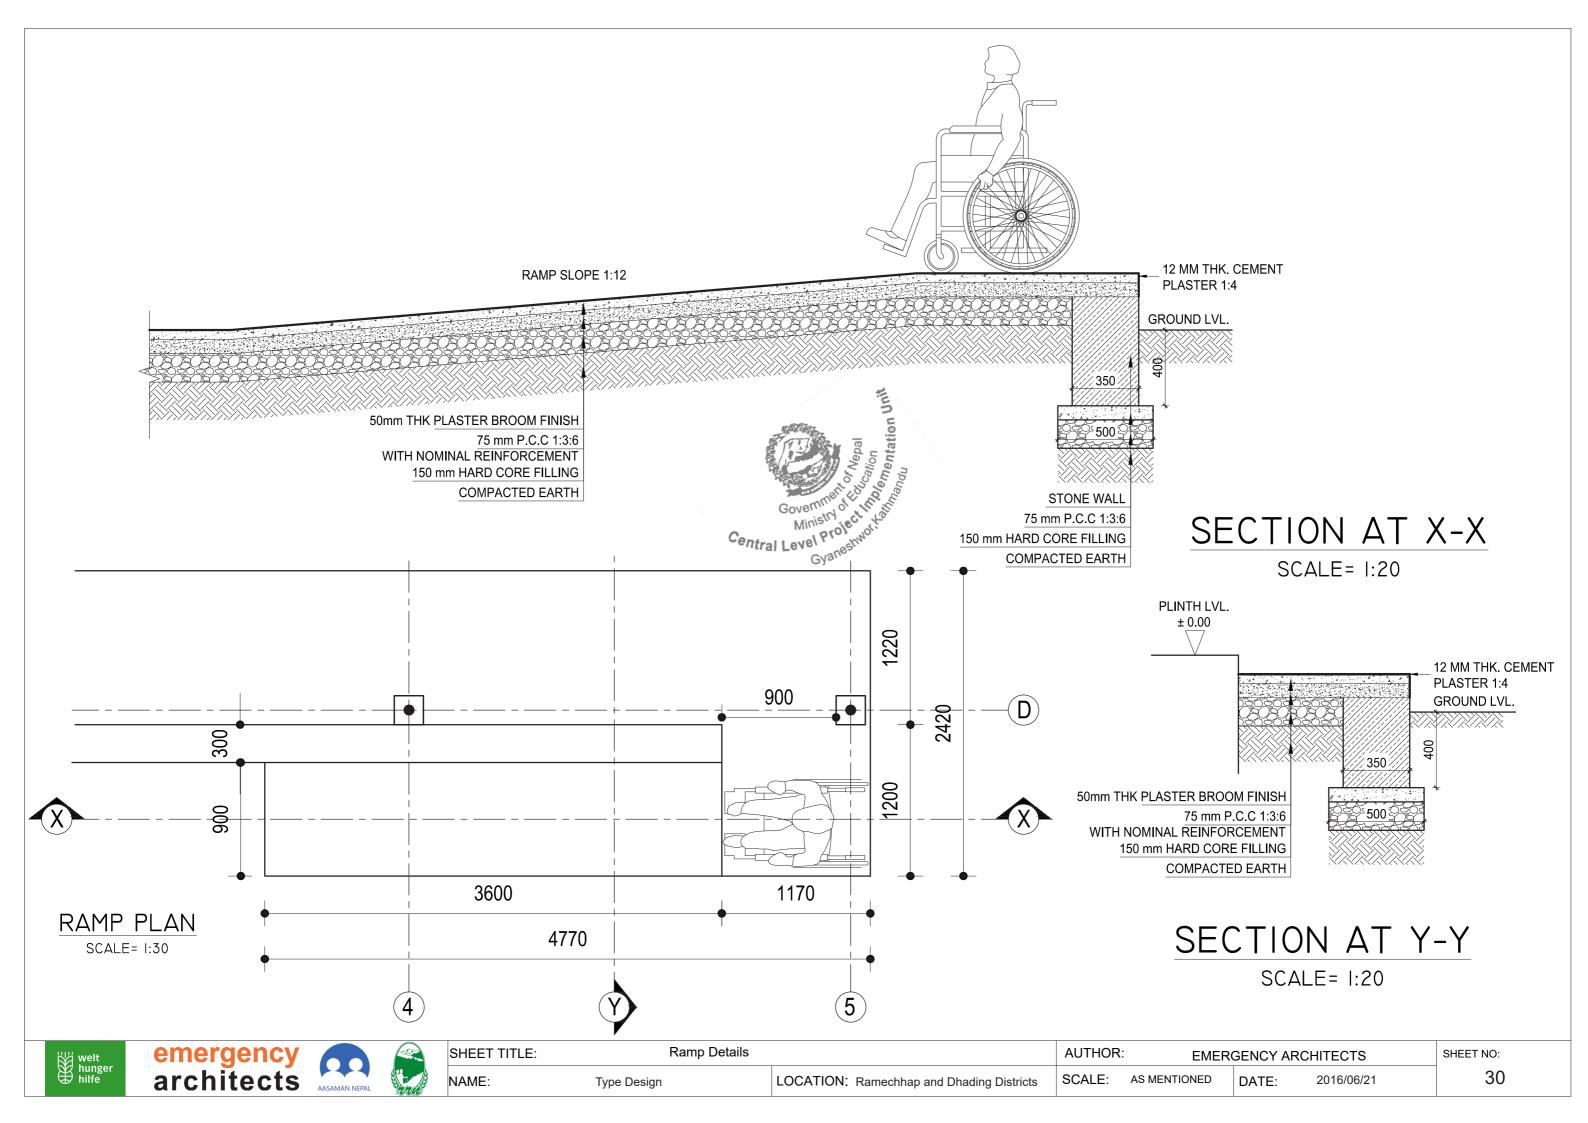

Master Plans

Ramechhap / Dhading











Master Plan

Shree Bhimeshwor Rudra Higher Secondary School











Master plan

Chakra Devi Lower Secondary School













| CHAKRA DEVI LOWER S. S. | | | | | | | |
|-------------------------|-------|-------|--|--|--|--|--|
| | Block | Rooms | | | | | |
| Type Design | 1 | 2 | | | | | |

l 0 m 10 m 20 m 30 m







| SHEET T | TITLE: | PROJECT MAST | ER PLAN | | AUTHOR: | | EMER | GENCY AR | CHITECTS | SHEET NO: |
|---------|-----------------------------|--------------|-----------|----------------------|---------|-------|------|----------|------------|-----------|
| NAME: | Chakra Devi Lower Secondary | School | LOCATION: | Salyantar-5, Dhading | SCALE: | 1:500 | | DATE: | 2016/06/21 | 35 |

Master plan


Chandeswari Primary School









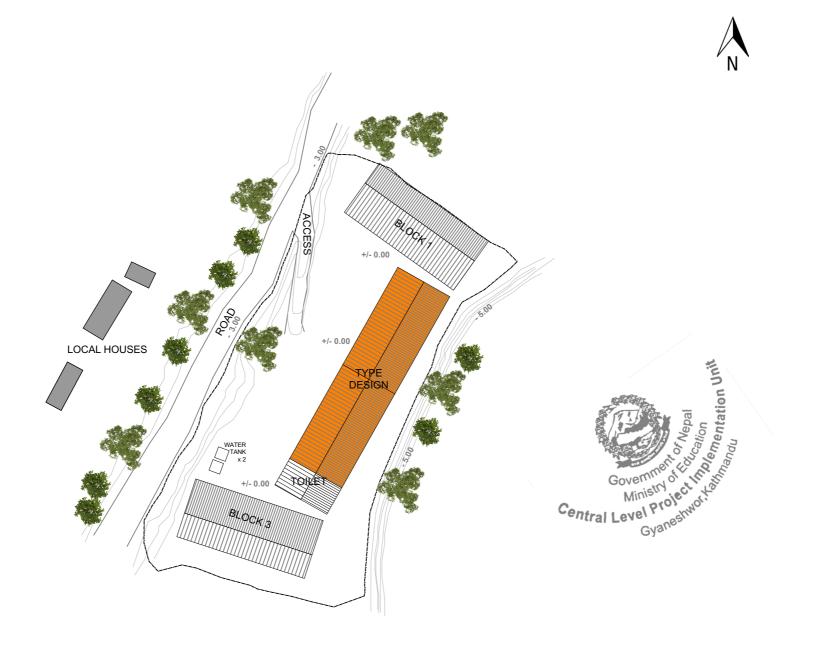

| CHANDESWARI PRIMARY SCHOOL | | | | | | |
|----------------------------|--------|-------|--|--|--|--|
| | Blocks | Rooms | | | | |
| Type Design | 2 | 4 | | | | |

0 m 10 m 20 m 30 m 50







| SHEET TITLE: | TITLE: PROJECT MASTER PLAN AI | | | AUTHOR: EMERGENCY ARCHITECTS | | | | | SHEET NO: | |
|--------------|-------------------------------|-----------|----------------------|------------------------------|-------|--|-------|------------|-----------|----|
| NAME: | Chandeswari Primary School | LOCATION: | Salyantar-2, Dhading | SCALE: | 1:500 | | DATE: | 2016/06/21 | | 37 |

Master plan

Janajyoti Lower Secondary School












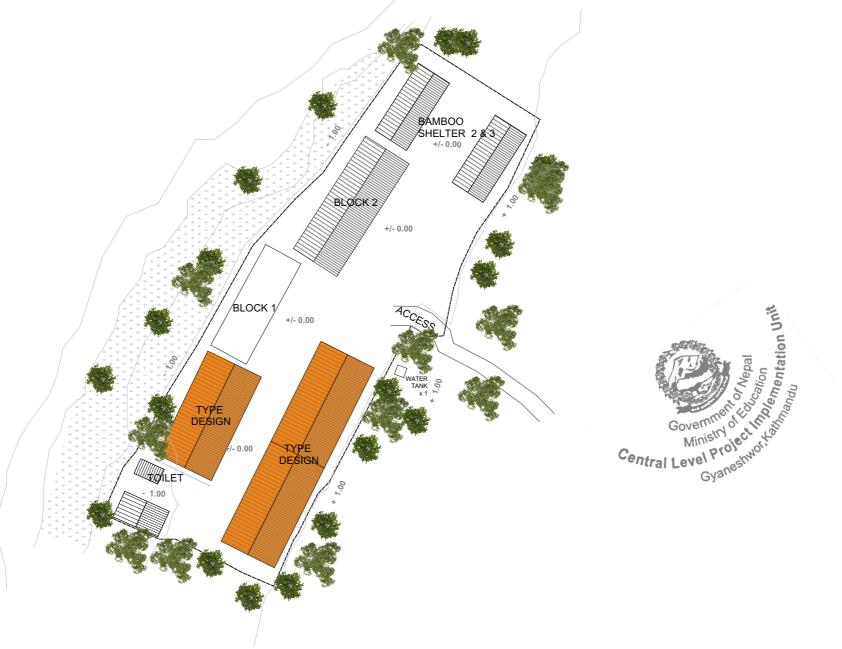



| | JANAJYOTI LOWER SECONDARY SCHOOL | | | | | | | |
|---|----------------------------------|--------|-------|--|--|--|--|--|
| | | Blocks | Rooms | | | | | |
| T | ype Design | 3 | 6 | | | | | |

0 m







| SHEET TITLE: PROJECT MASTER PLAN AU | | | AUTHOR: | SHEET NO: | | | | |
|-------------------------------------|----------------------------------|-----------|----------------------|-----------|-------|-------|------------|----|
| NAME: | Janajyoti Lower Secondary School | LOCATION: | Salyantar-3, Dhading | SCALE: | 1:500 | DATE: | 2016/06/21 | 39 |

Master plan

Mahalaxmi Higher Secondary School

















| AL | | |
|----|--|--|

| ı | SHEET TITLE. | FIX |
|---|--------------|-------------------------------|
| | NAME: | Mahalaxmi Higher Secondary Sc |

LOCATION: chool

Baseri-5, Dhading

SCALE:

1:500

DATE: 2016/06/21

41